

4822 E Palmetto St Florence, SC 29506 **OSE COMMENTS - 02.21.2025** 



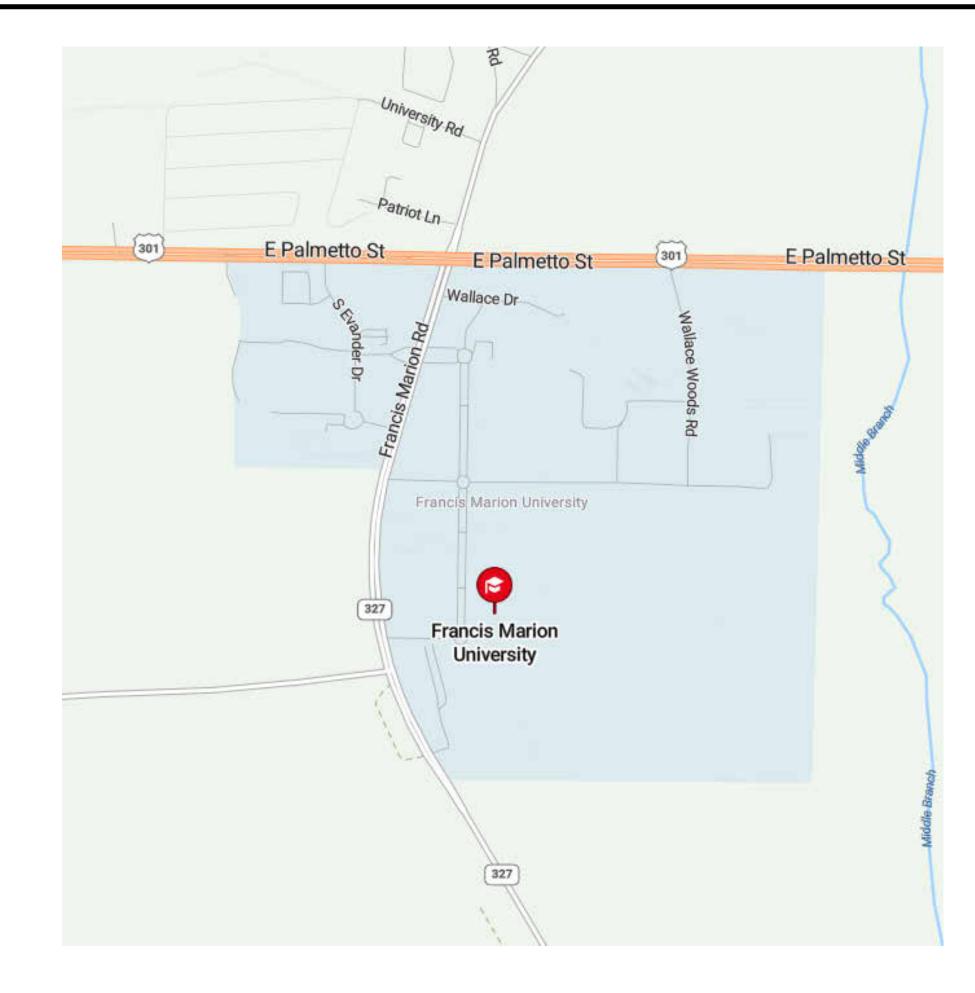

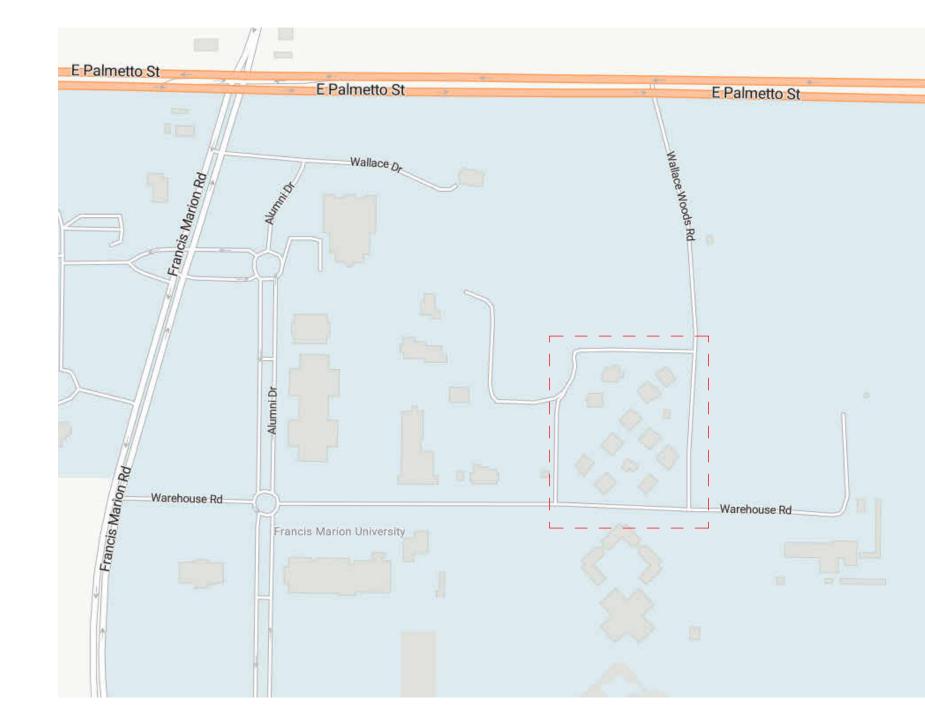

<u>OWNER</u> Francis Marion University 4822 E. Palmetto St. Florence, SC 29506

**OWNER'S REPRESENTATIVE** FMU - VP for Facilities

+ Construction 4822 E. Palmetto St Florence, SC 29506 (843) 661-1101 Ralph Davis

**ARCHITECT** 

Little Diversified **Architectural Consulting** 1360 Truxtun Ave, Suite 200 North Charleston, SC 29405 (843) 212-0354 **Don Baus** 

**MECHANICAL** Little Diversified Architectural Consulting

615 South College Street, Suite 1600 Charlotte, NC 28202 (704) 525-6350 Jason Svistun

**ELECTRICAL** Little Diversified

Architectural Consulting 615 South College Street, Suite 1600 Charlotte, NC 28202 (704) 525-6350 Matthew Schronce P.E.

**PLUMBING** 

Little Diversified **Architectural Consulting** 615 South College Street, Suite 1600 Charlotte, NC 28202 (704) 525-6350

Jason Svistun



This drawing and the design shown are the





1 OSE Comments

PRINCIPAL IN CHARGE D BAUS

H18-N095-SG

Village Apartments Interior Renovation, FMU 4822 E Palmetto St Florence, SC 29506 OSE PROJECT NUMBER -

PROJECT NO. 4142197600

SHEET TITLE COVER SHEET

ADDDE\/IATIONS

Abbr.	Abbreviated Phrase	Abbr.	Abbreviated Phrase	Abbr.	Abbreviated Phrase
ACT	ACOUSTIC CEILING TILE	FOB	FACE OF BRICK	OFF	OFFICE
.DA	AMERICANS WITH DISABILITIES ACT	FOG	FACE OF GLASS	ОН	OPPOSITE HAND
\DJ	ADJUSTABLE	FOS	FACE OF SHEATHING	OPNG	OPENING
AED	AUTOMATED EXTERNAL	FR	FIRE RETARDANT TREATED		
	DEFIBRILLATOR	FRP	FIBERGLASS REINFORCED PLASTIC	PED	PEDESTAL, PEDESTRIAN, PEDIATR
AFF	ABOVE FINISH FLOOR	FT	(POLYMER) FOOT, FEET	PERF	PERFORATE(D)
\L	ALUMINUM	FURR	FURR(ED), (ING)	PFB	PREFABRICATE(D)
	ALTERNATE	FUT	FUTURE	PFN	PREFINISH(ED)
AMC	ACOUSTICAL METAL CEILING	FWC	FABRIC WALL COVERING	PL, PLAM	PLASTIC LAMINATE
APC	ACOUSTICAL PANEL CEILING	FWP	FABRIC WALL COVERING FABRIC WRAPPED PANEL	PLAS	PLASTER, PLASTIC
APPROX	APPROXIMATE	IVVE	I ADINO WIVAFFED FAINEL	PLWD	PLYWOOD
ARCH	ARCHITECT(URAL)	GA	GAUGE	PNL	PANEL
ARP	ACRYLIC RESIN PANEL	GALV	GALVANIZED	PNT	PAINT(ED)
AWC	ACOUSTICAL WOOD CEILING	GALV	GLASS BOARD	PR	PAIR
	DULL ETIN DO ADD	GC	GENERAL CONTRACTOR	PT	PRESSURE TREAT(ED)
BBD	BULLETIN BOARD	GL	GLASS, GLAZING	PTN	PARTITION
BD	BOARD	GR	GROUT		
30	BOTTOM OF	GRAN	GRANITE	QT	QUARRY TILE
ВОТ	BOTTOM	GWB	GYPSUM WALL BOARD	QZ	QUARTZ, ENGINEERED QUARTZ
2/1 21	OFNITEDLINE	GVB GYP	GYPSUM WALL BOARD GYPSUM		
C/L, CL	CENTERLINE	OIF	OTT GOIVI	RB	RUBBER BASE
CAB	CABINET	НС	HOLLOW CORE	RBT	RUBBER TILE
CC	CUBICLE CURTAIN	HD	HAND DRYER	REC	RECEPTACLE
CIR	CIRCLE	HDR	HEADER	REF	REFERENCE, REFER
CLG	CEILING	HDW	HARDWARE	REFR	REFRIGERATOR
CLOS	CLOSET	HGT	HEIGHT	REM	REMOVE
CLR	CLEAR(ANCE)	HORIZ	HORIZONTAL(LY)	REQ'D	REQUIRED
COL	COLUMN	HR	HOUR	RM	ROOM
*	CONCRETE	HVAC	HEATING, VENTILATION, AND AIR	RS	RESILIENT
CONST	CONSTRUCTION	TIVAC	CONDITIONING		
CONT	CONTINUOUS / CONTINUE	HWD	HARDWOOD	S&R	SHELF AND ROD
CONTR	CONTRACTOR	5		SCW	SOLID CORE WOOD
COORD	COORDINATE	IBC	INTERNATIONAL BUILDING CODE	SECT	SECTION
CPT	CARPET	ID	INSIDE DIAMETER	SF	SQUARE FEET
CRB	COVED RUBBER BASE	INCL	INCLUDE(D), (ING)	SFRM	SPRAYED FIRE RESISTIVE MATERI
CT	CERAMIC OR PORCELAIN TILE	INSUL	INSULATE(D), (ING)	SHR	SHOWER
CTR	CENTER	INT	INTERIOR	SIM	SIMILAR
		11 1	INTERCOR	SPEC	SPECIFICATION(S)
D 	DRYER	JAN	JANITOR'S CLOSET	SS	STAINLESS STEEL
DBL	DOUBLE	JT	JOINT	SSM	SOLID SURFACE MATERIAL
	DEGREE	01	CONT	ST	STONE
DEMO	DEMOLISH / DEMOLITION	KIT	KITCHEN	STD	STANDARD
DET, DTL	DETAIL	KPL	KICK PLATE	STOR	STORAGE
DIA	DIAMETER	IXI L	MONT EXTE	SUSP	SUSPENDED
DIM 	DIMENSION	L	LENGTH		SUSPENDED CEILING
DR	DOOR	LAM	LAMINATE(D)	SV	SHEET VINYL
DS	DOWNSPOUT	LBL	LABEL	SYS	SYSTEM
DWG	DRAWING(S)	LCKR	LOCKER		
OWN	DOWN	LIN	LINOLEUM	TB	TACK BOARD
OWR	DRAWER	LT	LIGHT	TEMP	TEMPERED, TEMPORARY
<b>-</b> ^	FAOU	LVL	LAMINATED VENEER LUMBER	TME	TO MATCH EXISTING
ΞA 	EACH	LVT	LUXURY VINYL TILE	TYP	TYPICAL
EL	ELEVATION	_ • •		TZ	TERRAZZO
ELEC	ELECTRICAL	MATL	MATERIAL(S)		
ELEV	ELEVATOR STATE	MAX	MAXIMUM	UNO	UNLESS NOTED OTHERWISE
EOS	EDGE OF SLAB	MB	MARKER BOARD		
EP	EPOXY FLOORING	MECH	MECHANICAL	VB	VINYL BASE
EQ FORT	EQUAL(LY)	MFR	MANUFACTURE(R)	VCT	VINYL COMPOSITE TILE
EQPT	EQUIPMENT	MIN	MINIMUM	VERT	VERTICAL(LY)
ΞW	EACH WAY	MISC	MISCELLANEOUS	VIF	VERIFY IN FIELD
EWC	ELECTRIC WATER COOLER	MP	METAL PANEL	VIN	VINYL
EXIST	EXISTING	MTD	MOUNTED	VT	VINYL TILE
EXP	EXPANSION	MTL	METAL	VWC	VINYL WALL COVERING
EXT	EXTERIOR	MULL	MULLION		
				W	WIDTH
FAAP	FIRE ALARM ANNUNCIATOR PANEL	MWK	MILLWORK	W/	WITH
FACP	FIRE ALAM CONTROL PANEL	N	NORTH	W/O	WITHOUT
-BO	FURNISHED BY OTHERS	N	NORTH	WB	WOOD BASE
FDC	FIRE DEPARTMENT CONNECTION	NIC	NOT IN CONTRACT	WC	WATER CLOSET
ΞE	FIRE EXTINGUISHER	NO, #	NUMBER	WD	WOOD
EC	FIRE EXTINGUISHER CABINET	NR	NOISE REDUCTION	WGT	WEIGHT
=F	FINISH FLOOR	NRC	NOISE REDUCTION COEFFICIENT	WIN	WINDOW
		NTS	NOT TO SCALE		
FIN	FINISH(ED)	1410	1101 10 00/122	WM	WALK-OFF MAT/ FLOORING

# **GENERAL NOTES**

FACE OF

FLUOR

FO

FLUORESCENT

A. ALL WORK SHALL CONFORM TO THE CONTRACT DOCUMENTS WHICH INCLUDE THE OWNER/CONTRACTOR AGREEMENT, THE PROJECT MANUAL, THE DRAWINGS AND ALL ADDENDA AND MODIFICATIONS ISSUED BY THE ARCHITECT.

ON CENTER

WTW WALL TO WALL

- B. REVIEW DOCUMENTS AND VERIFY DIMENSIONS AND FIELD CONDITIONS WHEN APPLICABLE. CONFIRM THAT WORK IS BUILDABLE AS SHOWN. ANY CONFLICTS OR OMISSIONS SHALL BE IMMEDIATELY REPORTED TO THE ARCHITECT FOR CLARIFICATION PRIOR TO THE PERFORMANCE OF WORK. C. COMPLIANCE WITH INDUSTRY STANDARDS, METHODS OF CONSTRUCTION, AND INSTALLATION AND ERECTION OF ELEMENTS AND MATERIALS ARE
- THE CONTRACTOR'S RESPONSIBLITY. D. THE GC AND EACH SUBCONTRACTOR ARE CONTRACTOR IS REQUIRED TO BE FAMILIAR WITH THE ENTIRE SET OF THESE CONTRACT DOCUMENTS AND ARE IS RESPONSIBLE FOR COORDINATION OF THEIR WORK WITH OTHER TRADES. CORRECTIONS FOR UNCOORDINATED WORK WILL BE MADE AT THE CONTRACTOR'S EXPENSE.
- E. WORK NOTED "BY OTHERS" OR "NIC" SHALL BE PROVIDED BY OWNER OR UNDER SEPARATE CONTRACT. F. PROTECT AREAS ADJACENT TO WORK AREA FROM DAMAGE DURING CONSTRUCTION. PATCH AND REPAIR ALL DAMAGED AREAS TO MATCH ADJACENT FINISH AND ENSURE A SMOOTH SURFACE.DO NOT SCALE DRAWINGS. ALL PARTITION LOCATIONS, DIMENSIONS, AND TYPES, AND ALL
- DOOR AND WINDOW LOCATIONS SHALL BE AS SHOWN ON PARTITION PLAN. IN CASE OF CONFLICT, NOTIFY ARCHITECT. PARTITION PLAN SUPERSEDES G. COORDINATE AND PROVIDE METAL OR RATED SOLID WOOD (FIRE TREATED) BLOCKING IN PARTITIONS AND CEILINGS FOR ALL WALL HUNG AND
- CEILING ATTACHED ITEMS INCLUDING MILLWORK, EQUIPMENT, AND FURNITURE. COORDINATE WITH OWNER AND VENDOR TO IDENTIFY LOCATIONS AND SIZES OF ITEMS PROVIDED/INSTALLED BY OTHERS. H. PARTITIONS ARE DIMENSIONED FROM FINISH FACE TO FINISH FACE OF GYPSUM BOARD, UNLESS INDICATED OTHERWISE. DIMENSIONS MARKED "CLEAR", "HOLD", AND "MIN" SHALL BE MAINTAINED AND SHALL ALLOW FOR THICKNESS OF FINISHES. COORDINATE THICKNESS WITH FINISH
- SCHEDULE, SPECIFICATIONS, AND DETAILS. COLUMN CENTER LINES, OR GRID LINES, ARE SHOWN FOR DIMENSIONING, VERIFY EXACT LOCATIONS IN FIELD. J. PROVIDE PARTITION TYPE WITH THE HIGHEST UL AND/OR ACOUSTICAL PERFORMANCE RATING WHERE MORE THAN ONE PARTITION TYPE IS
- K. "ALIGN" SHALL MEAN TO ACCURATELY LOCATE FINISH FACES IN THE SAME PLANE.
- .. MATERIALS USED IN UL RATED ASSEMBLIES SHALL CONFORM TO REFERENCED STANDARDS. M. STENCIL BOTH SIDES OF UL RATED PARTITIONS ABOVE SCHEDULED CEILING WITH REQUIRED PROTECTION TEXT. N. FIRE STOP PENETRATIONS IN UL RATED ASSEMBLIES TO MAINTAIN/ACHIEVE LEVEL OF PROTECTION REQUIRED FOR ASSEMBLY TYPE. FIRE STOP ALONG PERIMETER OF RATED ASSEMBLIES WHERE VOIDS OCCUR. REFER TO UL DETAILS FOR MORE INFORMATION. GC SHALL NOTIFY THE ARCHITECT OF ANY PENETRATIONS TO RATED ASSEMBLIES NOT COVERED BY THE UL DETAILS PROVIDED IN THIS DRAWING SET AND PROVIDE
- DETAILS FOR ARCHITECT REVIEW PRIOR TO PROCEEDING WITH WORK. O. PROVIDE FIRE EXTINGUISHER CABINETS, SMOKE DETECTORS AND ALL OTHER LIFE SAFETY DEVICES AS REQUIRED BY CODE. PROVIDE DRAWING SHOWING LOCATION, OF DEVICES FOR REVIEW PRIOR TO FRAMING OF WALLS. DO NOT PLACE IN FIRE RATED PARTITIONS.
- P. PROVIDE HOT AND COLD WATER LINES, SOIL, VENT LINES AND PRESSURE AND SHUTOFF VALVES AS REQUIRED IN ACCORDANCE WITH LOCAL BUILDING AND PLUMBING CODES FOR PLUMBING FIXTURES. Q. COORDINATE SCHEDULE FOR TELEPHONE, DATA, SECURITY, AND AUDIO VISUAL INSTALLATIONS WITH TENANT AND OWNER.

#### SHEET INDEX SHEET NAME SHEET NUMBER 00 COVER SHEET COVER SHEET CS 01 GENERAL/LIFE SAFETY GENERAL INFORMATION AND SHEET INDEX G001 G002 BUILDING CODE SUMMARY G003 SITE PLAN G100 LIFE SAFETY PLAN - LEVEL 01 04 ARCHITECTURE

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AD111.AB AD111.C DEMOLITION PLAN - 1BR.C - LEVEL 01 AD111.D DEMOLITION PLAN - 4BR.D - LEVEL 01 OVERALL FLOOR PLAN - 1BR.AB - LEVEL 01 A101.AB A101.D OVERALL FLOOR PLAN - 4BR.D - LEVEL 01 A111.A ENLARGED FLOOR PLAN, CEILING PLAN, & ELEVATIONS - 1BR.A - LEVEL 01 A111.B ENLARGED FLOOR PLAN, CEILING PLAN, & ELEVATIONS - 1BR.B - LEVEL 01 A111.C ENLARGED FLOOR PLAN, CEILING PLAN, & ELEVATIONS - 1BR.C A111.D ENLARGED FLOOR PLAN, CEILING PLAN, &

08 PLUMBING/ 09 MECHANICAL MECHANICAL & PLUMBING COVER SHEET & SCHEDULES MP101.AB MECHANICAL & PLUMBING OVERALL FLOOR PLAN -

ELEVATIONS - 4BR.D - LEVEL 01

1BR.AB - LEVEL 01 MP101.D MECHANICAL & PLUMBING OVERALL FLOOR PLAN -4BR.D - LEVEL 01 MP111.AB MECHANICAL & PLUMBING ENLARGED FLOOR PLANS - 1BR.AB - LEVEL 01 MP111.C MECHANICAL & PLUMBING ENLARGED FLOOR PLANS - 1BR.C - LEVEL 01 MP111.D MECHANICAL & PLUMBING ENLARGED FLOOR PLANS - 4BR.D - LEVEL 01 MP501 MECHANICAL & PLUMBING DETAILS

10 ELECTRICAL

E000 ELECTRICAL COVER SHEET ELECTRICAL PLANS - 1BR. A/B E111.AB E111.C ELECTRICAL PLANS - 1BR. C E111.D ELECTRICAL PLANS - 4BR. D E500 ELECTRICAL DETAILS

# SHEET NUMBERING LEGEND

SYMBOLS

ARCHITECTURAL ELEMENTS

(0A00A)KX WALL TAG

**ROOM NAME** 

ROOM NUMBER

DOOR NUMBER

ALUMINUM FRAMING SYSTEM TAG

ACCESSORIES TAG

MATERIALS TAG

EQUIPMENT TAG

CARD READER

CEILING TYPE FINISH ELEVATION

WINDOW TAG

#### SHEET NUMBER STRUCTURE **DISCIPLINE DESIGNATORS** - DISCIPLINE DESIGNATOR CS COVER SHEET - SHEET TYPE DESIGNATOR SHEET SUB-TYPE DESIGNATOR - SHEET SEQUENCE NUMBER / BUILDING LEVEL — AREA / SEGMENT INDICATOR

G GENERAL / LIFE SAFETY H HAZARDOUS MATERIALS V SURVEY / MAPPING B GEOTECHNICAL LANDSCAPE A ARCHITECTURE INTERIORS

E ELECTRICAL

**VIEW ELEMENTS** 

1 SIM

A301

T TELECOM / DATA

X OTHER DISCIPLINES

DETAIL MARKER

SECTION MARKER

**EXTERIOR ELEVATION** 

MARKER

INTERIOR

MARKER

**ELEVATION** 

4 ENLARGEMENTS 5 DETAILS 6-9 (VARIES BY DISCIPLINE) S STRUCTURAL P PLUMBING F FIRE PROTECTION M MECHANICAL

SHEET TYPE DESIGNATORS

0 GENERAL INFORMATION

2 ELEVATIONS

**SITE & LOCATION ELEMENTS** 

**ANNOTATIONS** 


Level Name ELEVATION DATUM

COLUMN GRID AND GRID BUBBLES

NORTH ARROW

SHEET KEYNOTE

3 SECTIONS

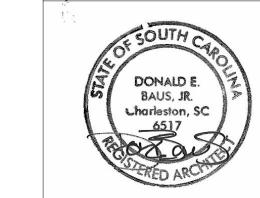

ARCHITECTURAL CONSULTING, INC.

No. C01205

North Charleston, SC 29405

to legal action.

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100% CDs

	ISSUE	DATE	
	02	.14.2025	
	REVISI		
	NO.	REASON	DATE
_	1	OSE Comments	02.21.2025

PROJECT TEAM PRINCIPAL IN CHARGE D BAUS PROJECT MANAGER S KERSCHEN DESIGN TEAM
C TURNER

Village Apartments Interior Renovation, FMU 4822 E Palmetto St Florence, SC 29506 OSE PROJECT NUMBER -H18-N095-SG

4142197600

PROJECT NO.

SHEET TITLE GENERAL INFORMATION AND SHEET INDEX

C:\Revit Local\FMU_Village Apts_R24_Interior Reno 2_caitlin.turner_L5JE464N8HDJ.r W:\Community\College and University\4142052600 FMU Village Apartments Interior Re	М	enovation\2 Design\4 Drawings\Revit
	C:\Revit Local\FMU_Village Apts_R24_Interior Reno 2_caitlin.turner_L5JE464N8HDJ.rv	W:∖Community∖College and University∖4142052600 FMU Village Apartments Interior Renovation∖2 Design∖4 Drawings∖Revit

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				DIVERSIFIED ARCHITECTUR	RAL CONSULTING	Applicable Codes:	
Code S	Summar	·V				Building:	2021 South Carolina Building Code or the 2021 International Building Code with SC modifications '21
A TOTAL						Fire:	2021 South Carolina Fire Code or the 2021 International Fire Code with SC modifications
Project Name:	Village Apartm	ents Interior Renov				Plumbing:	2021 South Carolina Plumbing Code or the 2021 International Plumbing Code with SC modifications
Address:	4822 E Palmet	tto St. Florence, SC	29506			Mechanical:	South Carolina Mechanical Code or the 2021 International Mechanical Code with SC modifications 2
Owner:	Francis Marior	57				Fuel Gas:	South Carolina Fuel Gas Code or the 2021 International Fuel Gas Code with SC modifications
	*	VP for Facilities + (	Construction			Electrical:	2020 National Electrical Code (NFPA 70) with SC modifications
Owner Contac	· ·					Energy:	2009 International Energy Conservation Code (Energy Standard Act)
		etto St. Florence, S	C 29506			Accessibility	
Owned By	(843) 661-1101		☐ Privat		 ☐ State	Building Data:	
Owned By:		y / County		е	□ State	Bldg. Area:	Existing; No change.
<b>Authority Havin</b>	g Jurisdiction (	· · · · · · · · · · · · · · · · · · ·				Bldg. Stories:	Existing; No change.
		∐ Cour □ State				Mezzanine:	N/A
			)	_		Bldg. Height:	Existing; No change.
Project Summa	ry:		—			Construction Type:	Existing; No change.
☐ New Construct	tion <b>[√]</b> Rer Alte	novation ( <i>Existing</i> ) eration <b>[</b> ]1 []	Upfit (. 2    □3	First Generation)		Sprinklers:	Existing; Not sprinklered.
Proposed Use:			-			Standpipes:	
Description:						Fire District:	
						Flood Zone:	
Design Team:		T		<u> </u>		Building Occupand	T .
Primary						Occupancy:	Residential (R-2)
Designer	Firm	Name	Phone	Email		Mixed Occupancy:	
Architect	Little	Don Baus	843.212.9768	don.baus@littleonline	e.com	Notes:	
	N/A						
· ·	N/A					Allowed Height	
	N/A					Allowed Height: Allowed Area:	
Plumbing	N/A					Allowed Area.	

Mechanical Electrical

Fire Protection N/A Fire Alarm N/A

> CODE SUMMARY 1 CODE SUMMARY 2




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 02.21.2025


PROJECT TEAM
PRINCIPAL IN CHARGE
D BAUS

PROJECT MANAGER
S KERSCHEN DESIGN TEAM
C TURNER

Village Apartments Interior Renovation, FMU 4822 E Palmetto St Florence, SC 29506 OSE PROJECT NUMBER -H18-N095-SG PROJECT NO.

4142197600

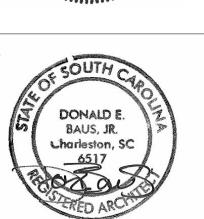SHEET TITLE BUILDING CODE SUMMARY

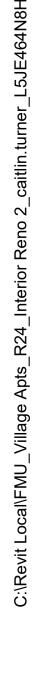






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Village Apartments Interior Renovation, FMU 4822 E Palmetto St Florence, SC 29506

OSE PROJECT NUMBER -H18-N095-SG PROJECT NO. 4142197600

SHEET TITLE SITE PLAN

G003

OCCUPANT LOAD Area per OCCUPANT
Occupant LOAD FUNCTION (USE) OF SPACE DESCRIPTION AREA LOAD RESIDENTIAL (GROSS) Not Placed 200 SF 916 SF 200 SF 517 SF 200 SF RESIDENTIAL (GROSS) RESIDENTIAL (GROSS) 475 SF 200 SF RESIDENTIAL (GROSS) 679 SF 200 SF RESIDENTIAL (GROSS) LEVEL 01 OCCUPANT LOAD 2588 SF

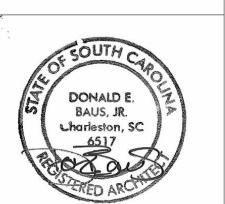-- CLEAR OPENING WIDTH
-- CLEAR WIDTH PER OCCUPANT OCCUPANT CAPACITY — ACTUAL OCCUPANT LOAD - PANIC HARDWARE - ACCESS CONTROL DEVICE (E.G. CARD READER) REQUEST TO EXIT - CLEAR STAIR WIDTH CLEAR WIDTH PER OCCUPANT — OCCUPANT CAPACITY — ACTUAL OCCUPANT LOAD TRAVEL DISTANCE SHOWN: 000' — EXIT EGRESS DISTANCE — EXIT EGRESS COMMON PATH EXIT EGRESS DEAD END DISTANCE DIAGONAL DISTANCE: 14' - 0" OVERALL DIAGONAL DISTANCE DISTANCE BETWEEN EXITS: 14' - 0" EXIT REMOTENESS DISTANCE Area Name 150 SF AREA Per Occupant ILLUMINATED EXIT SIGN FIRE EXTINGUISHER

LIFE SAFETY SYMBOLS

SHEET GENERAL NOTES A. ALL PARTITIONS TO BE EXISTING TO REMAIN AND ALL CURRENT FIRE RATINGS ARE TO BE MAINTAINED.

RESIDENTIAL (GROSS)

<u>1</u>

munimum many

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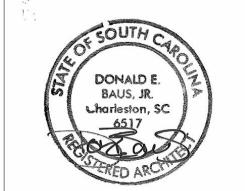
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1 OSE Comments

PROJECT TEAM

PRINCIPAL IN CHARGE

D BAUS PROJECT MANAGER
S KERSCHEN


Village Apartments Interior Renovation, FMU 4822 E Palmetto St Florence, SC 29506 OSE PROJECT NUMBER -H18-N095-SG

4142197600

PROJECT NO.

SHEET TITLE LIFE SAFETY PLAN - LEVEL


4A LIFE SAFETY PLAN - 4BR G100 1/4" = 1'-0"

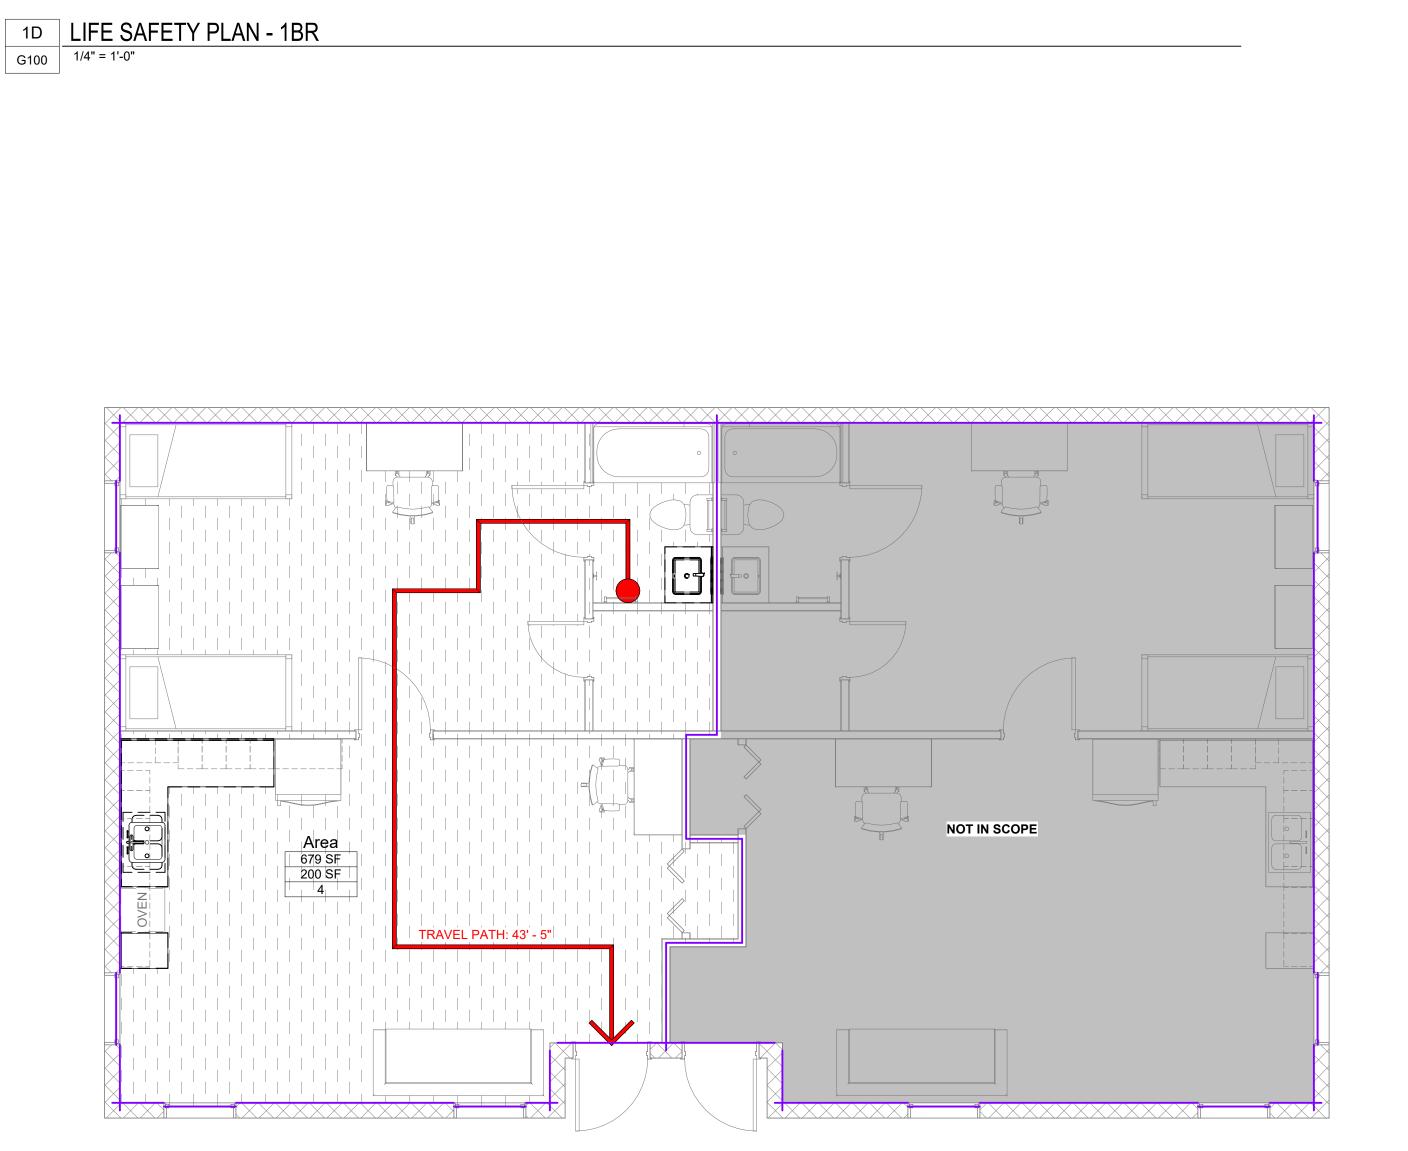

TRAVEL PATH: 36' - 5"

RESIDENTIAL (GROSS)


TRAVEL PATH: 48' - 7"

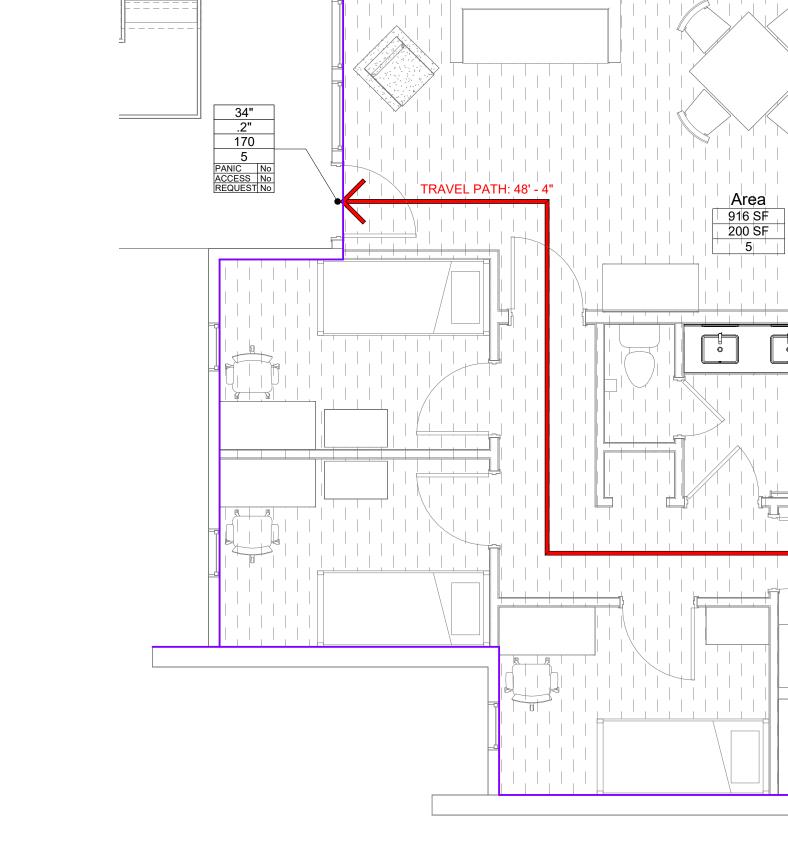


RESIDENTIAL (GROSS)

1A LIFE SAFETY PLAN - 1BR.C G100 1/4" = 1'-0"

G100

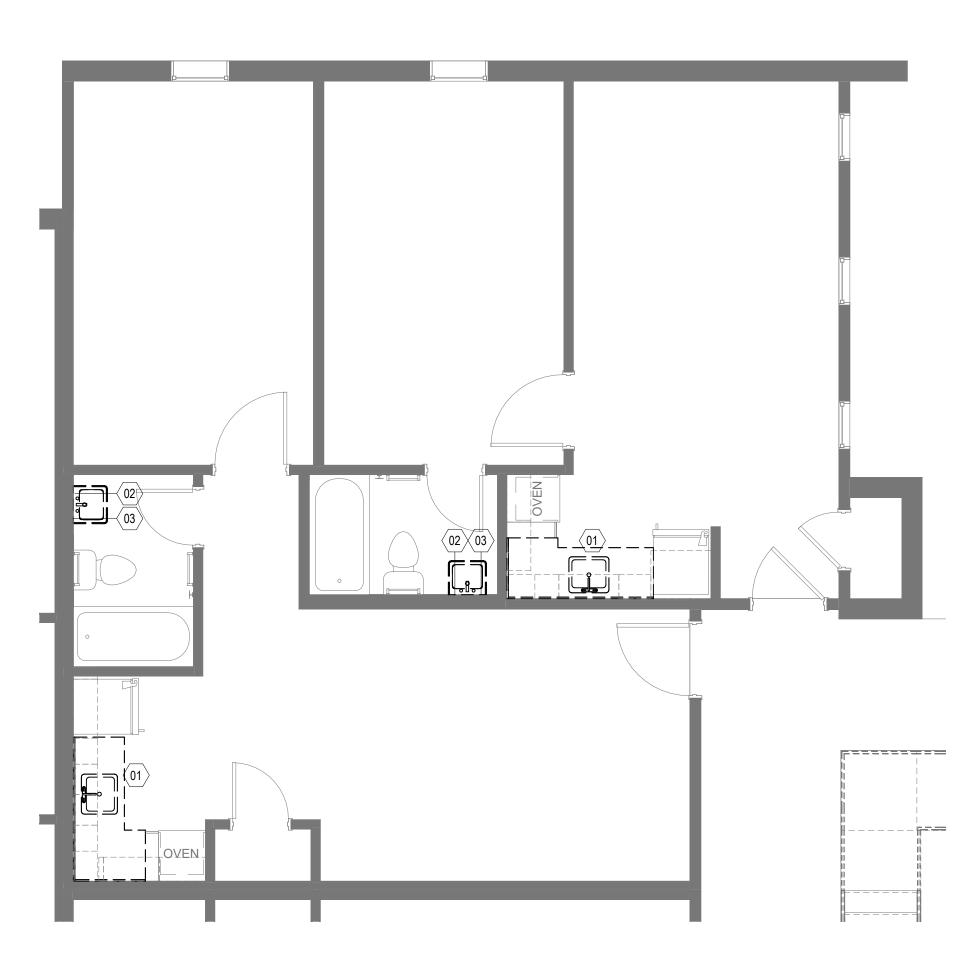

1D DEMOLITION PLAN - TYP. 1BR.AB

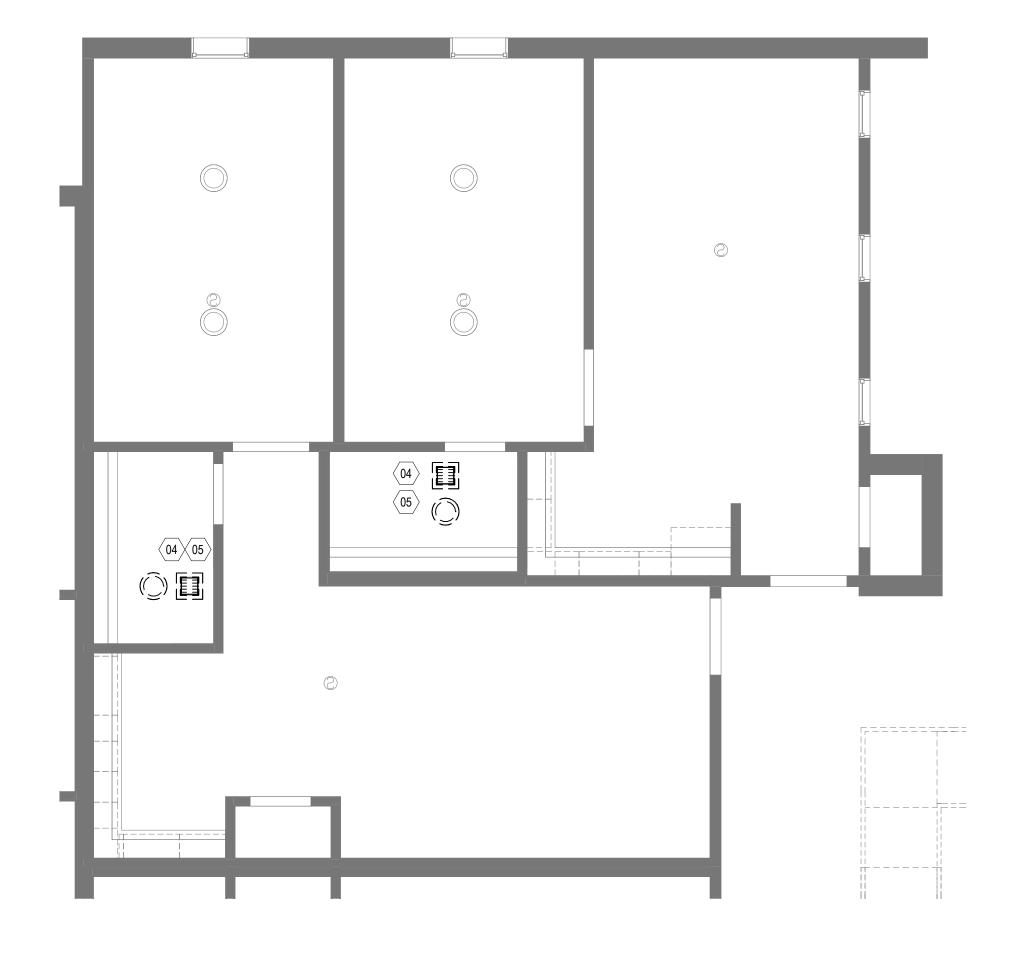

4D DEMOLITION REFLECTED CEILING PLAN - TYP. 1BR.AB

- 01 REMOVE ALL EXISTING COUNTERTOPS AND SINKS. CAP
  PLUMBING AT SOURCE. EXISTING CASEWORK TO REMAIN.
  REMOVE CABINET DOORS AND HARDWARE AND STORE FOR
  REINSTALLATION. REPAIR ANY DAMAGED AREAS ON CABINET
  BOXES, FACE FRAMES AND CABINET DOORS. CLEAN AND PREP
  SURFACES FOR NEW PAINT. ANY CASEWORK AREAS DAMAGED
  BEYOND REPAIR SHOULD BE EVALUATED AND REPLACED ON A
- CASE BY CASE BASIS. NOTIFY ARCHITECT AND OWNER OF THESE CONDITIONS AS THEY ARISE.

  02 REMOVE ALL EXISTING MIRRORS. PATCH, REPAIR, AND PAINT WALLS WHERE REQUIRED FOR INSTALLATION OF NEW
- ACCESSORIES.

  O3 EXISTING SCONCE TO BE REMOVED. PATCH, REPAIR, AND PAINT WALLS WHERE REQUIRED FOR INSTALLATION OF NEW FIXTURES.
- 04 REMOVE EXISTING MECHANICAL EXHAUST FAN AND CEILING LIGHT. PATCH, REPAIR AND PAINT CEILING WHERE REQUIRED FOR INSTALLATION OF NEW FIXTURES.
- 05 MODIFICATION OF EXISTING SWITCHES AND COVER PLATES REQUIRED PER INSTALLATION OF NEW FIXTURES.

DIVERSIFIED ARCHITECTURAL CONSULTING

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#### SHEET GENERAL NOTES

- A. VERIFY EXISTING JOB SITE CONDITIONS PERTAINING TO THE DEMOLITION WORK INDICATED AND/OR IMPLIED ON THE DRAWINGS AND REPORT ANY DISCREPANCIES AND/OR OMISSIONS WHICH WOULD INTERFERE WITH SATISFACTORY COMPLETION OF THE WORK. NOTIFY ARCHITECT IMMEDIATELY UPON DISCOVERY OF ANY FIELD CONDITION IN CONFLICT WITH NEW WORK. DO NOT PROCEED UNTIL ARCHITECT EVALUATES CONCERNS IN QUESTION.
- B. THIS PLAN IS NOT A COMPLETE REPRESENTATION OF ALL EXISTING CONDITIONS. IT IS INTENDED TO SHOW THE EXTENT OF DEMOLITION. SEE KEYED SHEET NOTES, DEMOLITION DETAILS, AND FLOOR PLANS FOR ADDITIONAL INFORMATION. EVERYTHING INDICATED FOR REMOVAL IS TO BE REMOVED IN ITS ENTIRETY, INCLUDING HIDDEN MATERIALS.
- C. ALL DEBRIS BECOMES THE PROPERTY OF THE CONTRACTOR AND SHALL BE REMOVED DAILY FROM THE PREMISES AT THE CONTRACTOR'S EXPENSE AND BE DISPOSED OF ACCORDING TO LOCAL CODES AND GOVERNING AUTHORITIES. VERIFY SALVAGE MATERIALS WITH THE OWNER'S REPRESENTATIVE.


  D. REPAIR/PATCH OPENINGS IN WALLS, PARTITIONS, FLOORS, AND
- CEILINGS THAT ARE EXISTING OR WHERE DEMOLITION OCCURS TO MATCH EXISTING ADJACENT FINISH SURFACE. MAINTAIN CODE AND FIRE RATING REQUIREMENTS.
- E. EXISTING FINISHES TO BE REMOVED SHALL HAVE THE ORIGINAL SUBSTRATE PREPARED TO RECEIVE NEW FINISHES.
   F. PROVIDE SAFE MEANS OF EGRESS THROUGH AND/OR AROUND THE
- BUILDING AND/OR SITE AT ALL TIMES AS WELL AS ACCESS TO ALL UTILITY CLOSETS AS REQUIRED.

  G. CONTACT ARCHITECT IF EXTENT OF DEMOLITION IS UNCLEAR OR IS
- H. WORK SHALL BE DONE IN ACCORDANCE WITH APPLICABLE AND CURRENT BUILDING CODES AND ALL OTHER CODES THAT HAVE AUTHORITY OVER THIS PROJECT. SECURE REQUIRED PERMITS. PROVIDE NECESSARY SAFEGUARDS, BARRIERS, TEMPORARY POWER, LIGHTING, FIRE PROTECTION, ETC. AS REQUIRED DURING DEMOLITION.
  I. DEBRIS REMOVAL IS TO BE CONDUCTED IN A MANNER NOT TO
- INTERFERE WITH OCCUPIED SPACES.

  J. ALL EXISTING STRUCTURAL ELEMENTS ARE TO REMAIN UNDISTURBED UNLESS NOTED OTHERWISE.
- K. PATCH AND REPAIR ANY DAMAGE TO FIRE PROOFING FOUND DURING DEMOLITION.
  L. COORDINATE LIGHTING REQUIREMENTS WITH ELECTRICAL DRAWINGS TO MAINTAIN ADEQUATE LIGHTING TO MEET LIFE SAFETY REQUIREMENTS. LIGHT FIXTURES SHALL BE SUPPORTED FROM SLAB
- ABOVE.

  M. THOROUGHLY CLEAN ALL SURFACES REMAINING DURING
  CONSTRUCTION AS REQUIRED TO PREPARE SPACE FOR NEW
  CONSTRUCTION. SURFACES THAT ARE ADJACENT TO SURFACES TO
  BE DEMOLISHED ARE TO BE PROTECTED AND RESTORED AS
  NECESSARY AS PART OF THE SCOPE OF WORK. RESTORATION
  SHALL EXTEND TO THE NEAREST BREAK IN THE SURFACE.
- N. ALL SPARE BREAKERS AVAILABLE AFTER COMPLETION OF THE PROJECT SHALL BE SWITCHED TO THE "OFF" POSITION.
  O. PRIOR TO AND DURING DEMOLITION, ALL ELEMENTS REQUESTED BY OWNER TO BE SALVAGED SHALL BE REMOVED AND DELIVERED TO AN AREA DESIGNATED BY THE OWNER OR TO A SECURE STORAGE UNDER THE CONTRACTOR'S CONTROL. ALL PRECAUTIONS SHALL BE TAKEN TO ENSURE ITEMS FOR RELOCATION ARE PRESERVED
- P. COORDINATE REMOVAL OF FURNISHINGS, FIXTURES, AND EQUIPMENT IN ROOMS PRIOR TO THE START OF DEMOLITION.



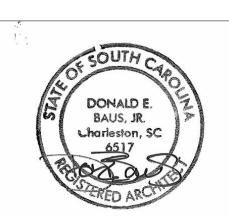

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02.14.2025


REVISIONS

REASON

1 OSE Comments 02.21.2025

KEY PLAN

BUILDINGS I, K

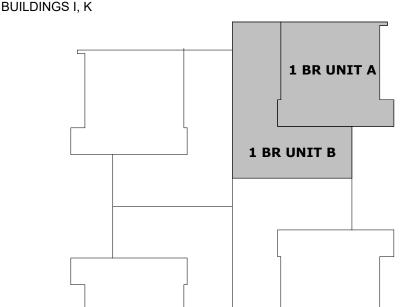

D BAUS

PROJECT MANAGER
S KERSCHEN

DESIGN TEAM
C. TURNER

PROJECT TEAM
PRINCIPAL IN CHARGE


Village Apartments Interior Renovation, FMU 4822 E Palmetto St Florence, SC 29506

OSE PROJECT NUMBER -H18-N095-SG

4142197600

DEMOLITION PLAN -1BR.AB - LEVEL 01

AD111.AB

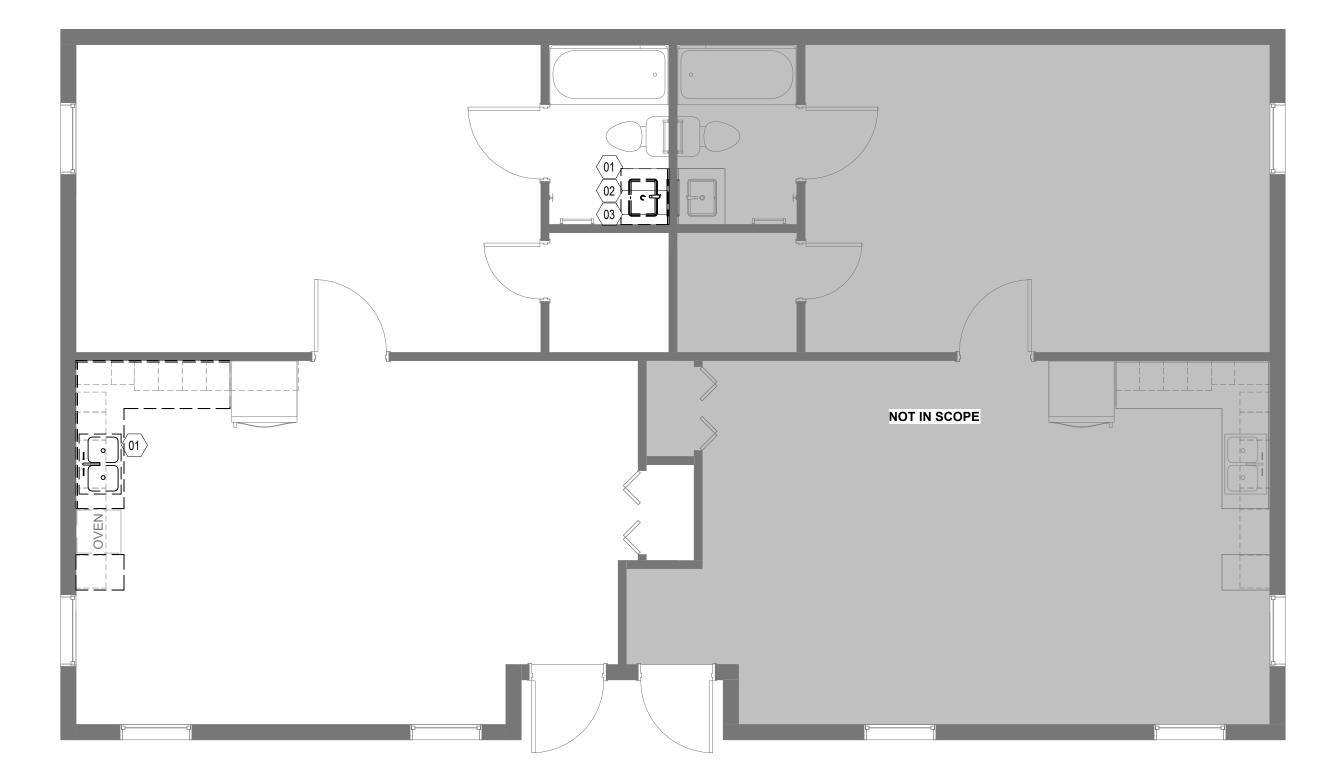



1D DEMOLITION PLAN - 1BR.C AD111.C 1/4" = 1'-0"

4D DEMOLITION REFLECTED CEILING PLAN - 1BR.C AD111.C 1/4" = 1'-0"

× SHEET KEYED NOTES

01 REMOVE ALL EXISTING COUNTERTOPS AND SINKS. CAP PLUMBING AT SOURCE. EXISTING CASEWORK TO REMAIN. REMOVE CABINET DOORS AND HARDWARE AND STORE FOR REINSTALLATION. REPAIR ANY DAMAGED AREAS ON CABINET BOXES, FACE FRAMES AND CABINET DOORS. CLEAN AND PREP SURFACES FOR NEW PAINT. ANY CASEWORK AREAS DAMAGED BEYOND REPAIR SHOULD BE EVALUATED AND REPLACED ON A CASE BY CASE BASIS. NOTIFY ARCHITECT AND OWNER OF

THESE CONDITIONS AS THEY ARISE. REMOVE ALL EXISTING MIRRORS. PATCH, REPAIR, AND PAINT WALLS WHERE REQUIRED FOR INSTALLATION OF NEW

ACCESSORIES. EXISTING SCONCE TO BE REMOVED. PATCH, REPAIR, AND PAINT WALLS WHERE REQUIRED FOR INSTALLATION OF NEW

04 REMOVE EXISTING MECHANICAL EXHAUST FAN AND CEILING LIGHT. PATCH, REPAIR AND PAINT CEILING WHERE REQUIRED FOR INSTALLATION OF NEW FIXTURES.

05 MODIFICATION OF EXISTING SWITCHES AND COVER PLATES REQUIRED PER INSTALLATION OF NEW FIXTURES.

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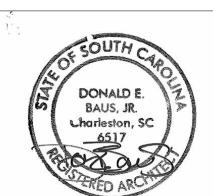
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- 2. ALL DEBRIS BECOMES THE PROPERTY OF THE CONTRACTOR AND SHALL BE REMOVED DAILY FROM THE PREMISES AT THE CONTRACTOR'S EXPENSE AND BE DISPOSED OF ACCORDING TO LOCAL CODES AND GOVERNING AUTHORITIES. VERIFY SALVAGE MATERIALS WITH THE OWNER'S REPRESENTATIVE. D. REPAIR/PATCH OPENINGS IN WALLS, PARTITIONS, FLOORS, AND
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- M. THOROUGHLY CLEAN ALL SURFACES REMAINING DURING CONSTRUCTION AS REQUIRED TO PREPARE SPACE FOR NEW CONSTRUCTION. SURFACES THAT ARE ADJACENT TO SURFACES TO BE DEMOLISHED ARE TO BE PROTECTED AND RESTORED AS NECESSARY AS PART OF THE SCOPE OF WORK. RESTORATION SHALL EXTEND TO THE NEAREST BREAK IN THE SURFACE. N. ALL SPARE BREAKERS AVAILABLE AFTER COMPLETION OF THE
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100% CDs

02.14.2025 1 OSE Comments 02.21.2025

PROJECT TEAM PRINCIPAL IN CHARGE D BAUS PROJECT MANAGER S KERSCHEN


C. TURNER

Village Apartments Interior Renovation, FMU 4822 E Palmetto St Florence, SC 29506

OSE PROJECT NUMBER -H18-N095-SG PROJECT NO. 4142197600

SHEET TITLE DEMOLITION PLAN - 1BR.C - LEVEL 01

AD111.C

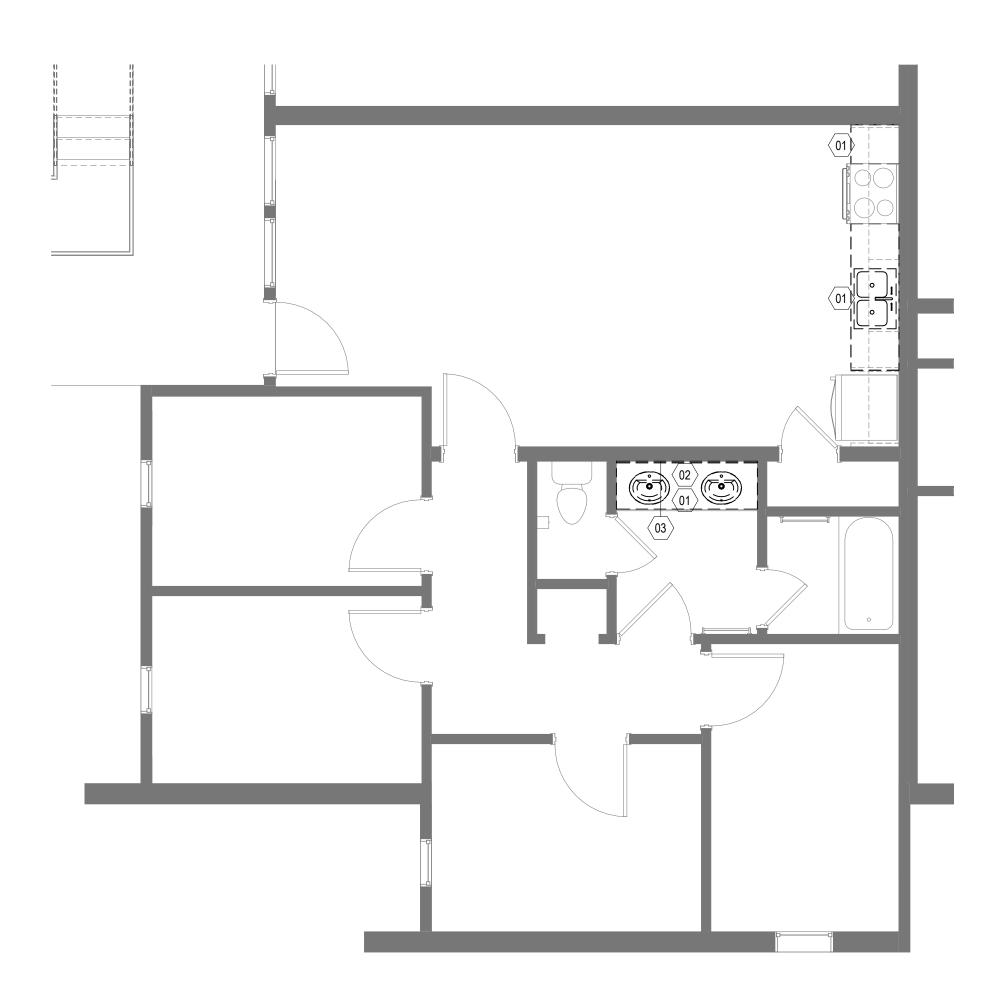

AD111.D 1/4" = 1'-0"

4D DEMOLITION REFLECTED CEILING PLAN - TYP. 4BR.D 1D DEMOLITION PLAN - TYP. 4BR.D AD111.D 1/4" = 1'-0"

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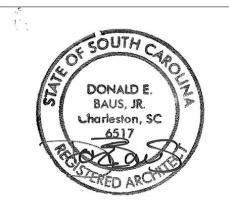
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100% CDs

02.14.2025

1 OSE Comments 02.21.2025

**KEY PLAN** 

BUILDINGS A-B, D-H, J, L-M 4 BR UNIT

PRINCIPAL IN CHARGE D BAUS PROJECT MANAGER S KERSCHEN DESIGN TEAM
C. TURNER

PROJECT TEAM


Village Apartments Interior Renovation, FMU 4822 E Palmetto St

Florence, SC 29506 OSE PROJECT NUMBER -H18-N095-SG PROJECT NO.

4142197600

SHEET TITLE DEMOLITION PLAN - 4BR.D - LEVEL 01

AD111.D

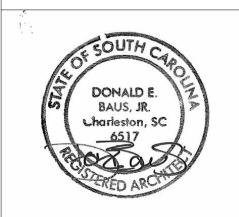

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1 OSE Comments

PROJECT TEAM
PRINCIPAL IN CHARGE
D BAUS

PROJECT MANAGER
S KERSCHEN

1 BR UNIT A

1 BR UNIT A (MIRROR)

1 BR UNIT B

1 BR UNIT B (MIRROR)

**KEY PLAN** 

BUILDINGS I, K

1 BR UNIT A (MIRROR)

1 BR UNIT A

UNIT B (MIRROR)

1 BR UNIT B

DESIGN TEAM
Designer
PROJECT NAME


Village Apartments Interior Renovation, FMU 4822 E Palmetto St Florence, SC 29506

OSE PROJECT NUMBER - H18-N095-SG
PROJECT NO.

4142197600

SHEET TITLE OVERALL FLOOR PLAN -1BR.AB - LEVEL 01

A101.AB

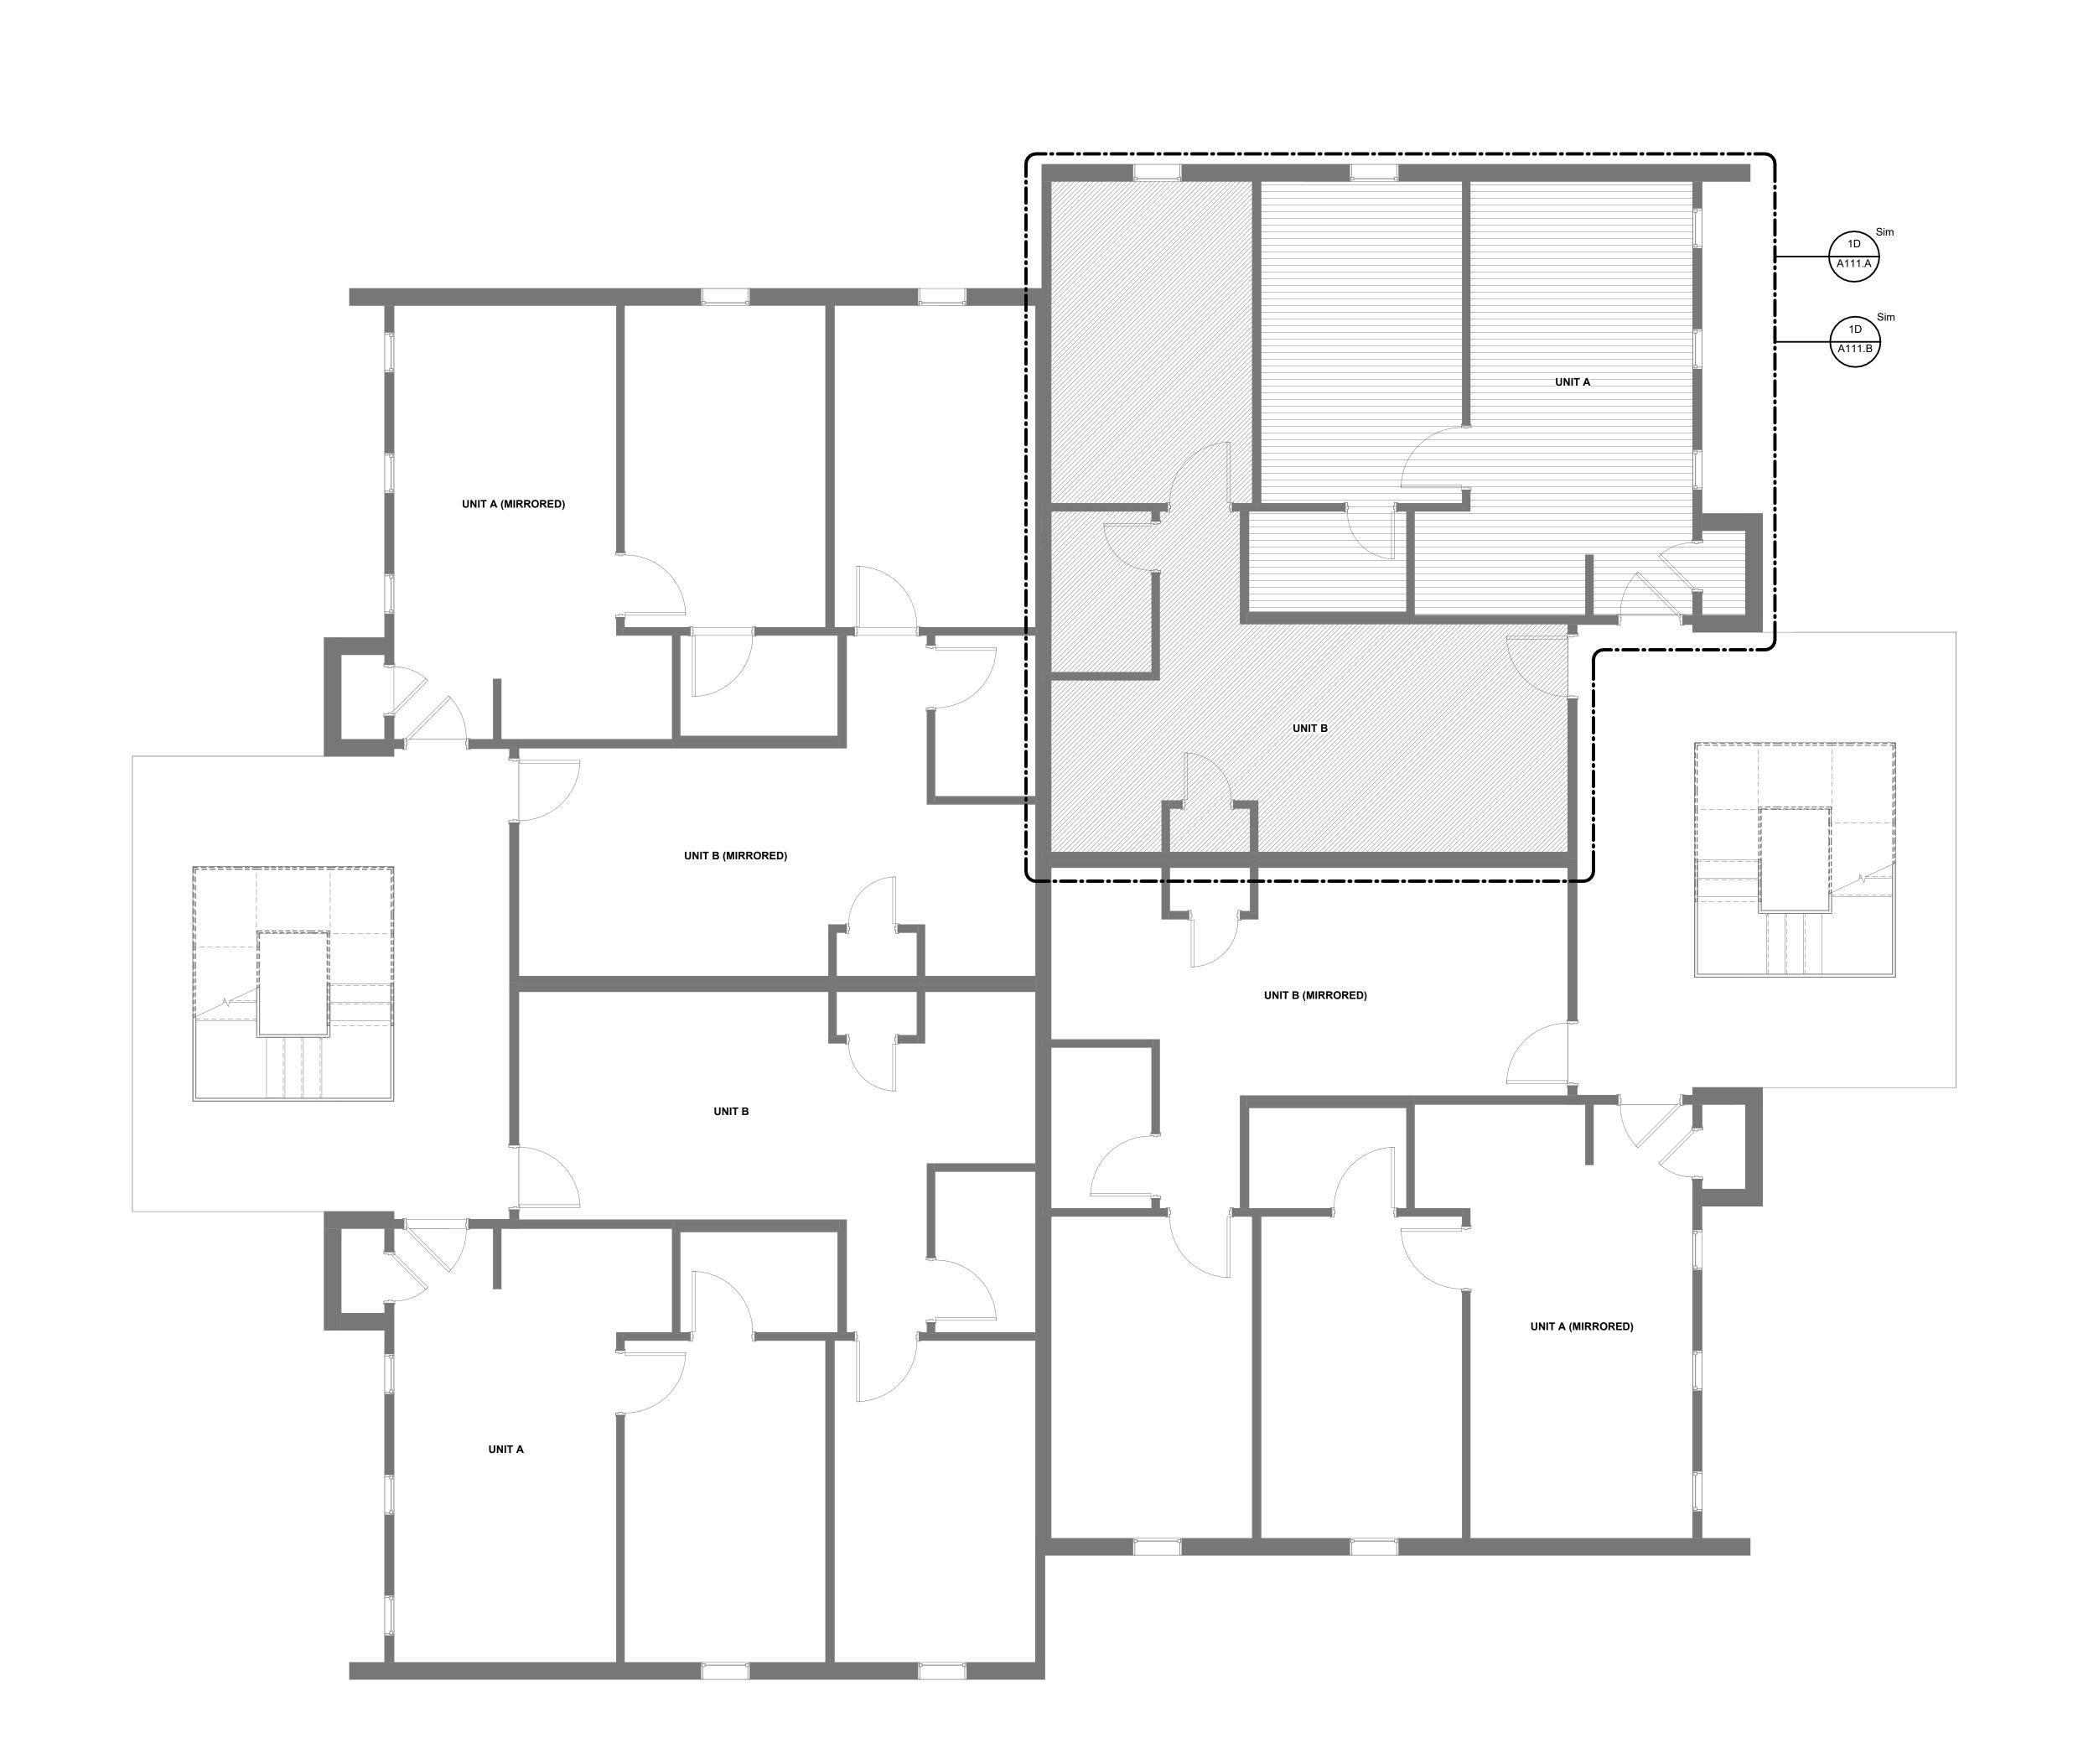



A101.AB 1/4" = 1'-0"

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1 OSE Comments

PROJECT TEAM
PRINCIPAL IN CHARGE
D BAUS PROJECT MANAGER
S KERSCHEN

**KEY PLAN** 


BUILDINGS A-B, D-H, J, L-M


DESIGN TEAM
Designer
PROJECT NAME


Village Apartments Interior Renovation, FMU 4822 E Palmetto St Florence, SC 29506


4 BR UNIT 4 BR UNIT (MIRROR) OSE PROJECT NUMBER -H18-N095-SG PROJECT NO. 1A OVERALL PLAN - 4BR.D - LEVEL 01


1/4" = 1'-0" 4142197600 SHEET TITLE 4 BR UNIT (MIRROR) OVERALL FLOOR PLAN -4BR.D - LEVEL 01 4 BR UNIT A101.D

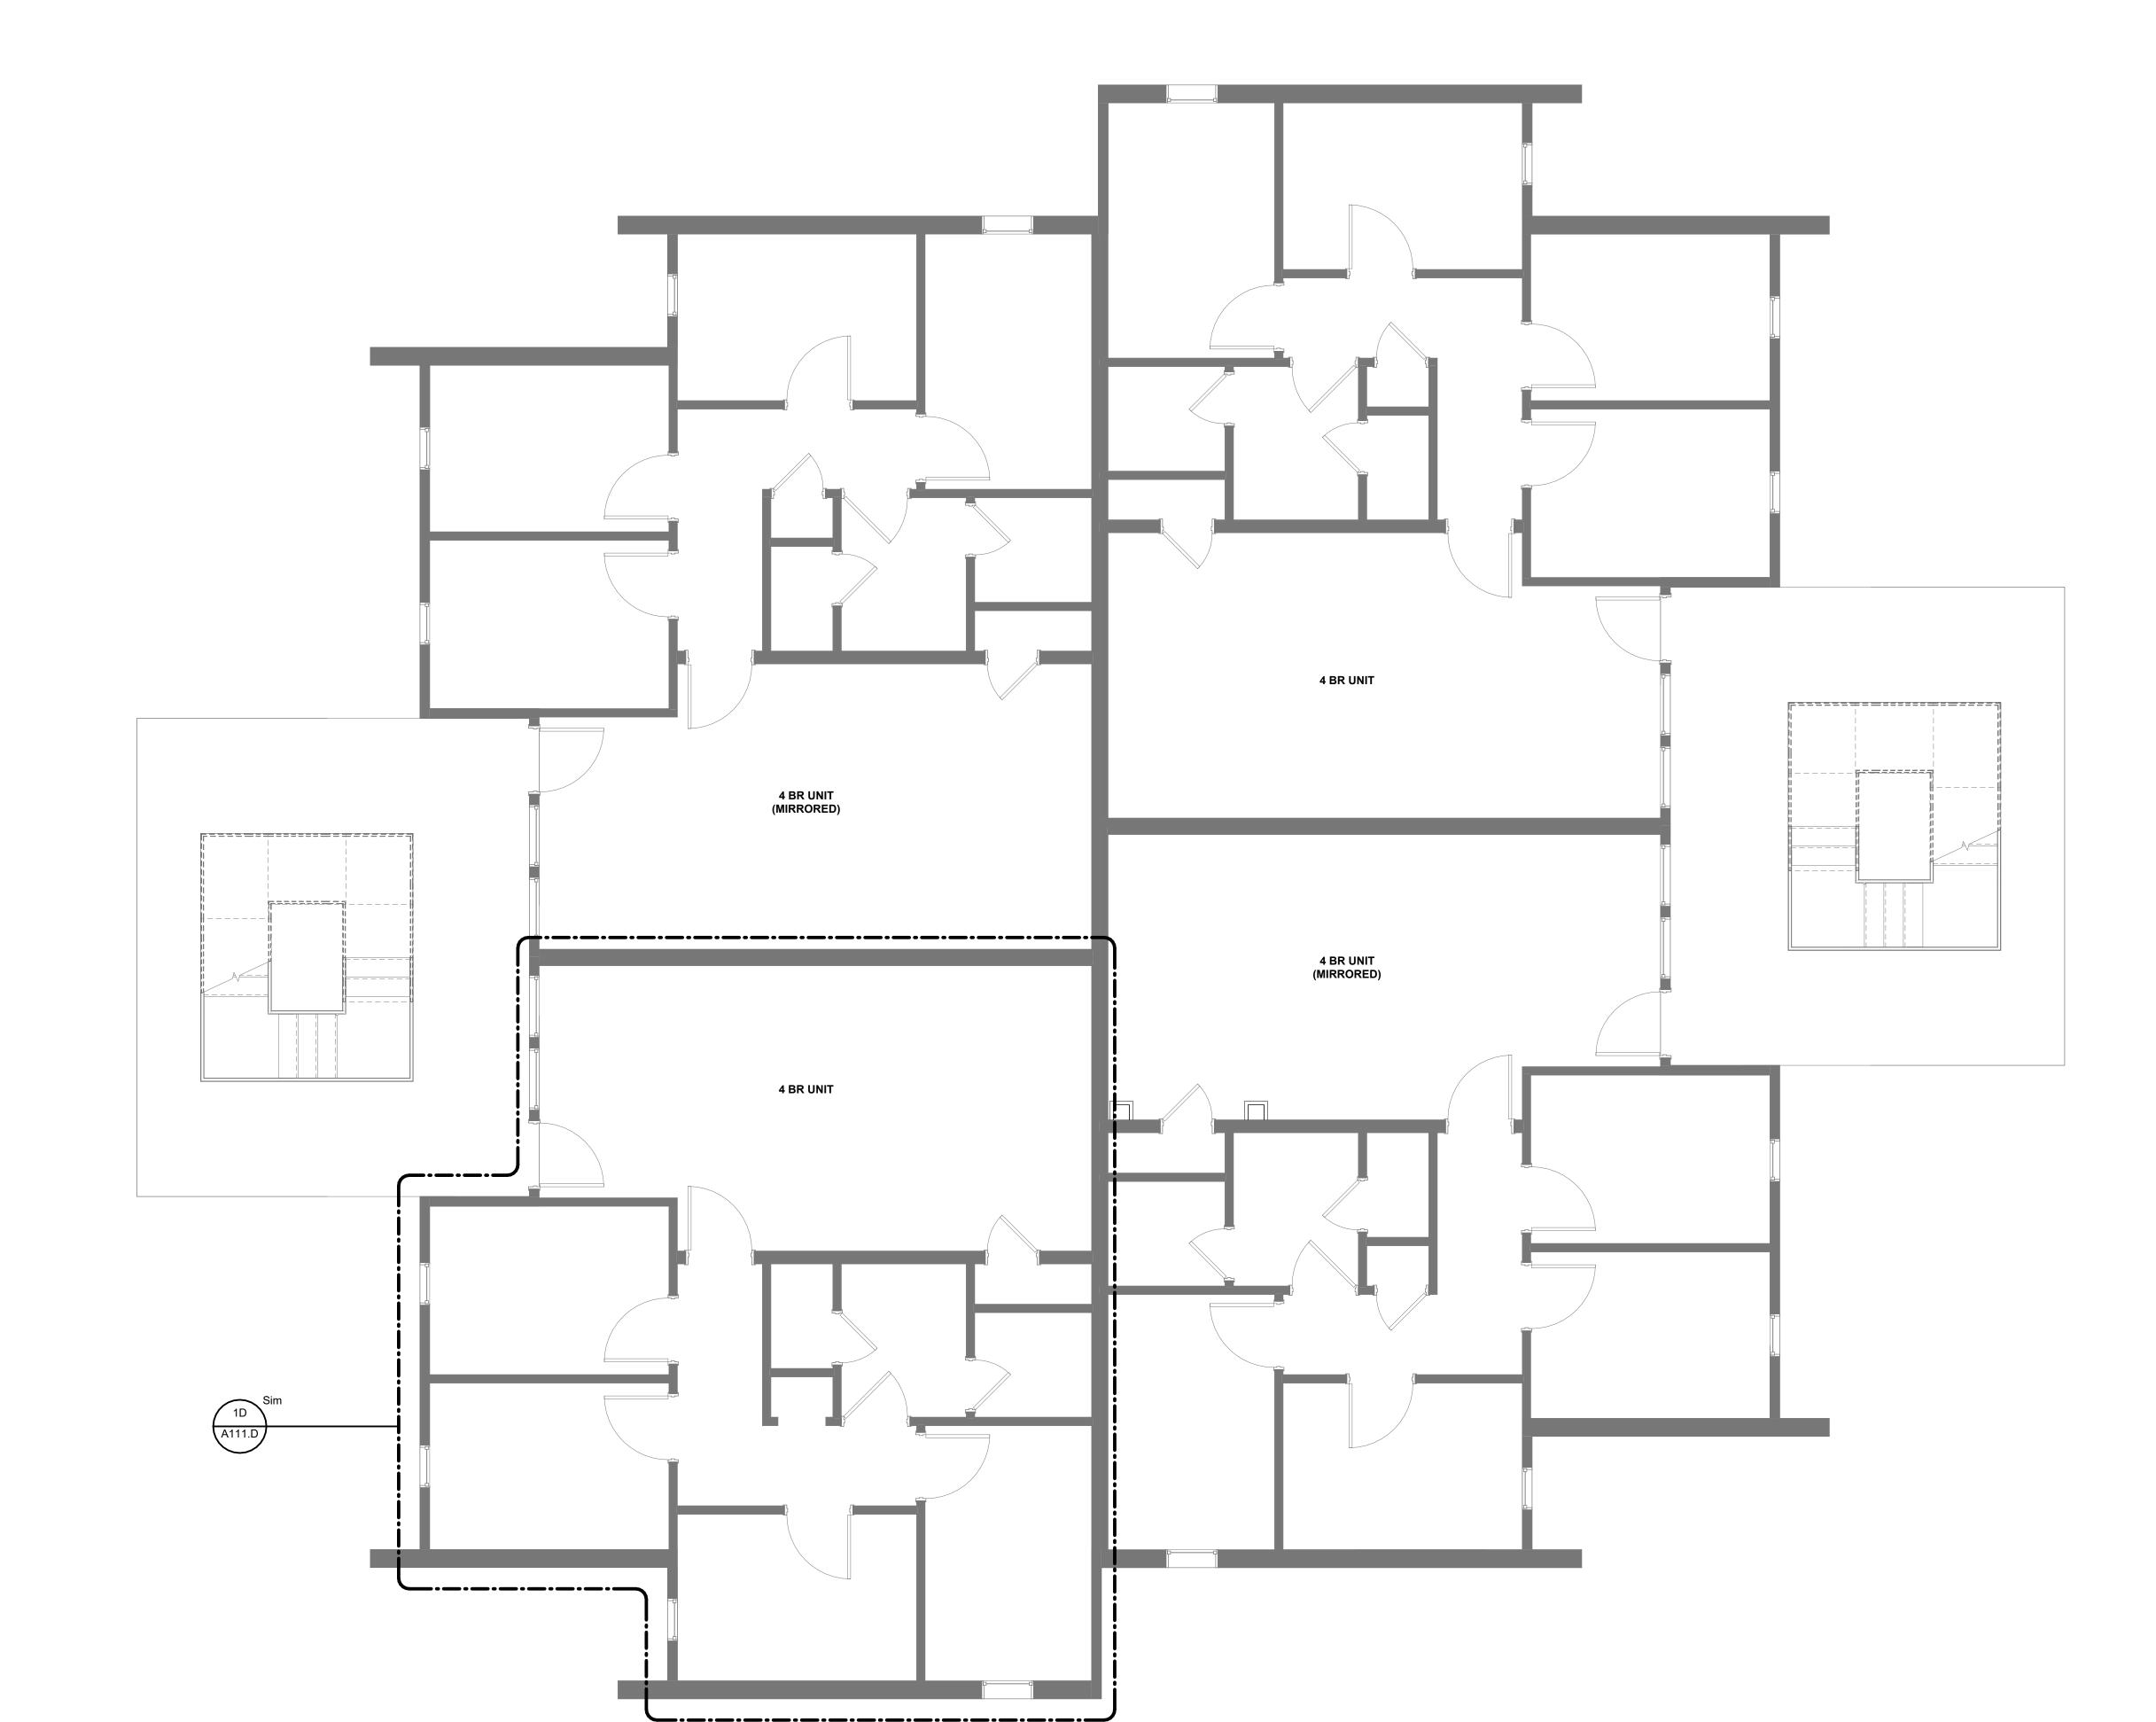

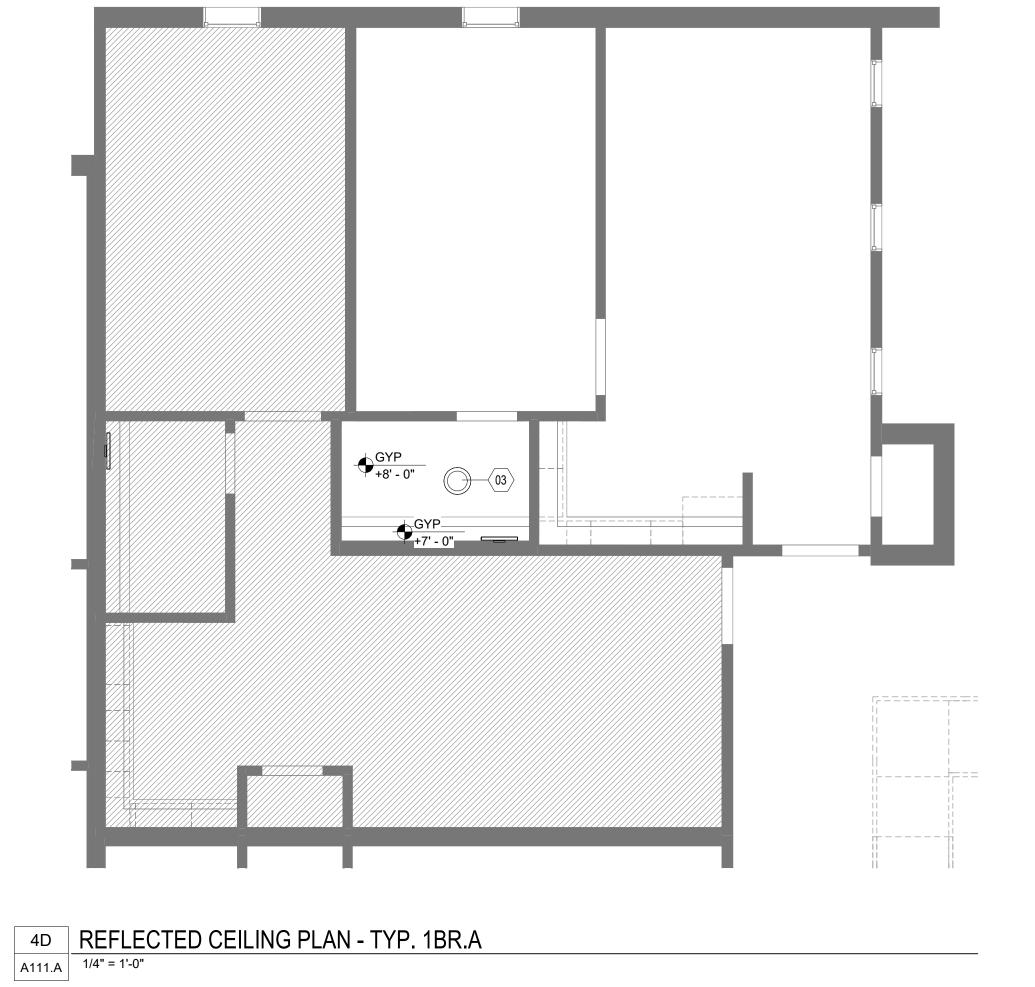

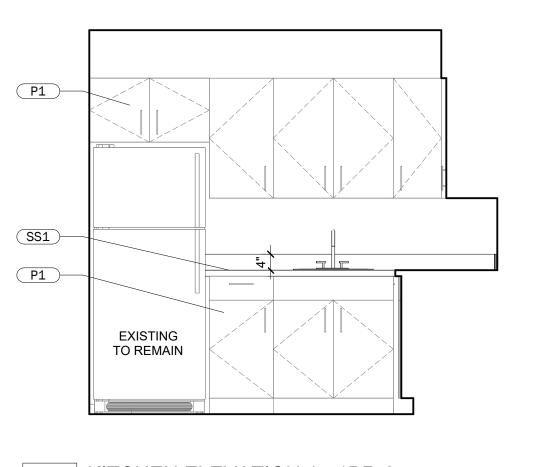


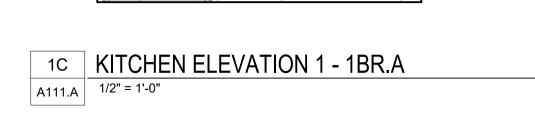

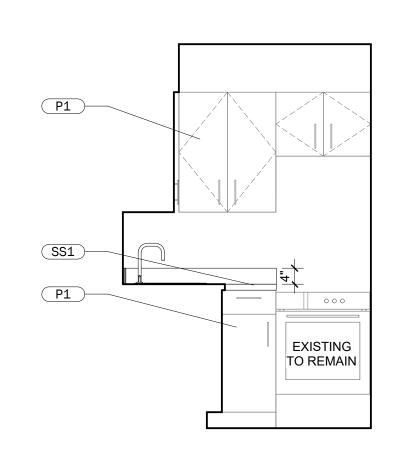


2C KITCHEN ELEVATION 2 - 1BR.A

1/2" = 1'-0"

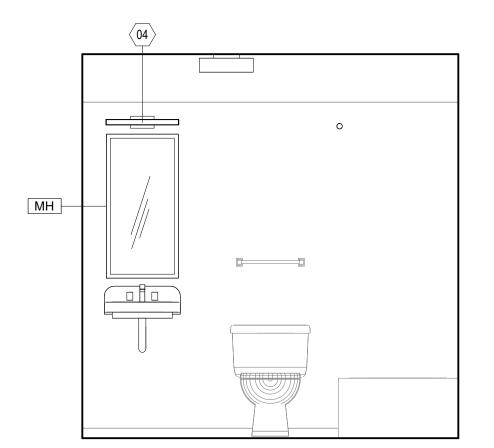


4C BATHROOM ELEVATION, TYP. 1BR.A

1/2" = 1'-0"

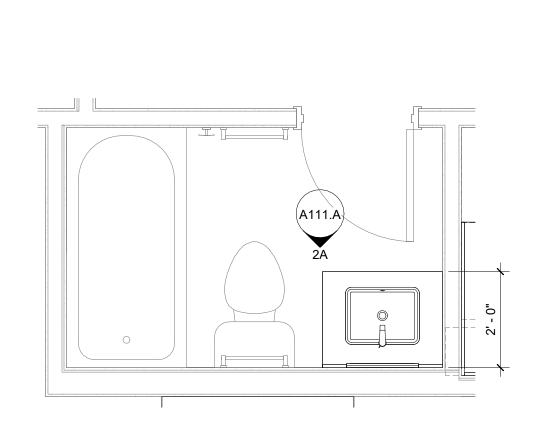



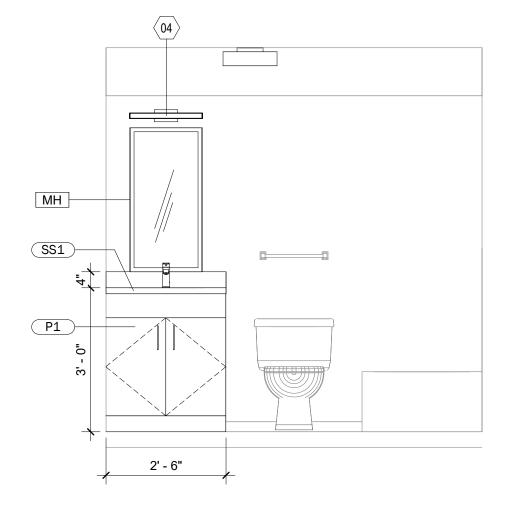

ADD ALT 1, BATHROOM ELEVATION 1BR.A A111.A 1/2" = 1'-0"

FINISH SCHEDULE								
FINISH CATEGORY	FINISH TYPE & NUMBER	TYPE DESCRIPTION	MANUFACTURER	PRODUCT	COLOR	FINISH	SIZE	LOCATION
CASEWORK								
CASEWORK	P1	PAINT		VARIES BY CABINET MATERIAL. SEE SPECIFICATIONS.	SW9178 IN THE NAVY	SATIN		EXISTING KITCHEN AND BATHROOM CASEWORK
CASEWORK	SS1	SOLID SURFACE	LG HI-MAC	SOLID SURFACE	RIPE COTTON G518R		30" X 145" SHEETS	KITCHEN, BATHROOM

TOILET ACCESSORIES SCHEDULE							
Type Mark	Manufacturer	Model	Description				
main							

#### SHEET GENERAL NOTES

- A. TYPICAL UNIT LAYOUT SHOWN. CONTRACTOR TO VERIFY DIMENSIONS AND FIELD CONDITIONS TO CONFIRM CONSTRUCTABILITY. ANY CONFLICTS OR OMISSIONS SHALL BE IMMEDIATELY REPORTED TO THE ARCHITECT FOR CLARIFICATION PRIOR TO THE PERFORMANCE OF WORK. EXACT DEVICE AND FIXTURE LOCATIONS MAY VARY. COORDINATE WITH EXISTING
- CONDITIONS ON A UNIT BY UNIT BASIS. B. WORK NOTED "BY OTHERS" OR "NIC" IS NOT IN CONTRACT. C. WORK OUTSIDE "AREA OF WORK", IS NOT IN CONTRACT, UNLESS
- OTHERWISE NOTED. D. EXISTING WALL SURFACES AND PARTITIONS TO REMAIN SHALL BE
- PATCHED, SPACKLED AND SANDED SMOOTH SO AS NOT TO LEAVE ANY EVIDENCE OF DEMOLITION OR REPAIR WORK. E. PROVIDE OR REUSE HOT AND COLD WATER LINES, SOIL, VENT LINES
- AND PRESSURE AND SHUTOFF VALVES AS REQUIRED IN ACCORDANCE WITH LOCAL BUILDING AND PLUMBING CODES FOR PLUMBING FIXTURES. F. COORDINATE AND PROVIDE FIRE RETARDANT BLOCKING IN
- PARTITIONS AND CEILING FOR MILLWORK, WALL AND CEILING ATTACHED ITEMS. G. DO NOT SCALE DRAWINGS. ALL PARTITION LOCATIONS, DIMENSIONS
- AND TYPES, DOOR AND WINDOW LOCATIONS SHALL BE AS SHOWN ON PARTITION PLAN. IN CASE OF CONFLICT, NOTIFY ARCHITECT.
- PARTITION PLAN SUPERSEDES OTHER PLANS. H. PARTITIONS ARE DIMENSIONED FROM FINISH FACE TO FINISH FACE, UNLESS OTHERWISE NOTED. DIMENSIONS MARKED "CLEAR" SHALL BE MAINTAINED AND SHALL ALLOW FOR THICKNESS OF FINISHES.

#### SHEET KEYNOTES

**KEY PLAN** 

BUILDINGS I, K

- 01 PRIME AND PAINT EXISTING UPPER AND LOWER CABINET BOXES, FACE FRAMES AND DOORS. INSTALL NEW SOLID SURFACE COUNTER TOP WITH 4" BACKSPLASH.
- 02 BASE BID: REPLACE EXISTING WALL HUNG SINK. ADD ALT 1: INSTALL NEW BASE CABINETS AND SOLID SURFACE TOP WITH NEW UNDERMOUNT SINK. SEE DETAILS 1A/A111.A + 2A/A111.A
- 03 NEW CEILING MOUNTED EXHAUST FAN WITH INTEGRATED LIGHT. 04 NEW SCONCE TO REPLACE EXISTING LOCATION.
- 05 BASE BID: REPLACE EXISTING WALL HUNG SINK. ADD ALT 1: INSTALL NEW BASE CABINETS AND SOLID SURFACE TOP WITH NEW UNDERMOUNT SINK. SEE DETAILS 1A/A111.B + 2A/A111.B



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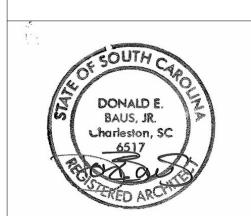
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NO. REASON

1 OSE Comments

PROJECT TEAM
PRINCIPAL IN CHARGE
D BAUS

1 BR UNIT A

PROJECT MANAGER
S KERSCHEN

Design TEAM
Designer
PROJECT NAME

Village Apartments Interior Renovation, FMU 4822 E Palmetto St Florence, SC 29506


PROJECT NO. 4142197600

OSE PROJECT NUMBER -H18-N095-SG


SHEET TITLE ENLARGED FLOOR PLAN, CEILING PLAN, & ELEVATIONS - 1BR.A -LEVEL 01

A111.A




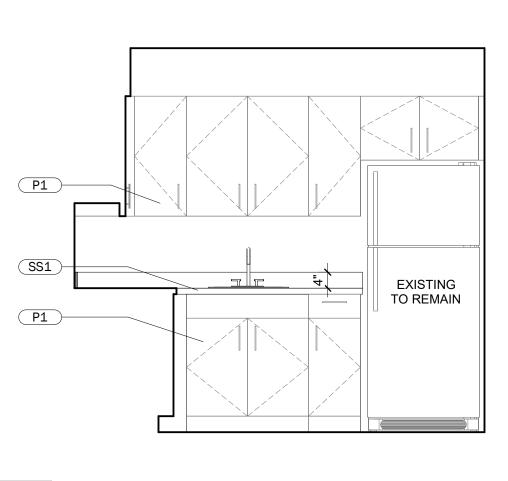



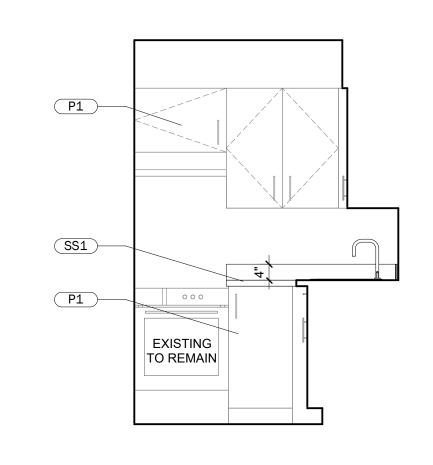


2C	KITCHEN ELEVATION 2 - 1BR.B
A111.B	1/2" = 1'-0"

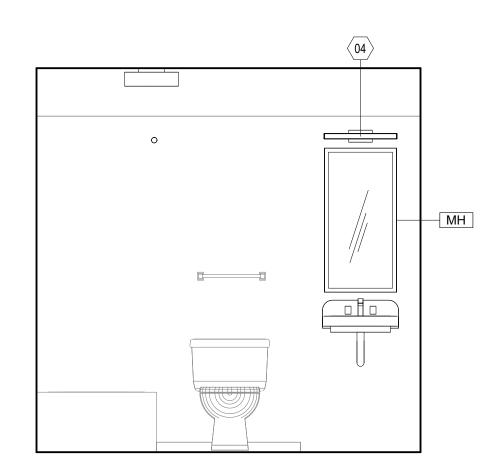


4C BATHROOM ELEVATION, TYP. - 1BR.B A111.B 1/2" = 1'-0"

A111.B 1/4" = 1'-0"

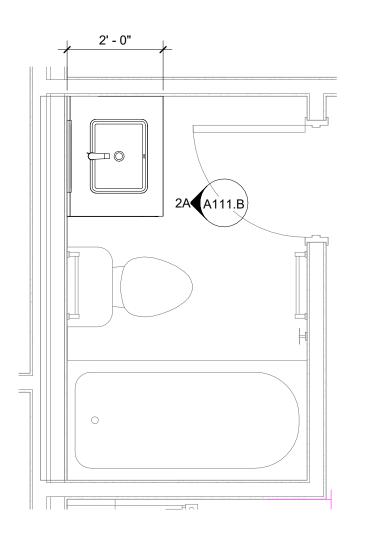

1A ADD ALT 1, BATHROOM PLAN 1BR.B A111.B 1/2" = 1'-0"

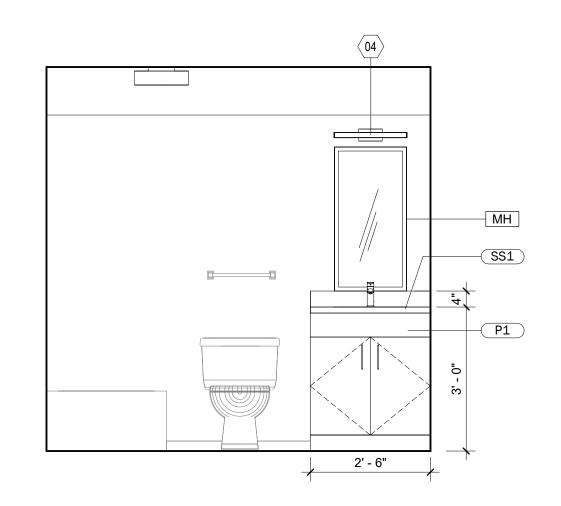

2A	ADD ALT 1, BATHROOM ELEVATION 1BR.B
Δ111 R	1/2" = 1'-0"

	FINISH SCHEDULE								
FINISH CATEGORY	FINISH TYPE & NUMBER	TYPE DESCRIPTION	MANUFACTURER	PRODUCT	COLOR	FINISH	SIZE	LOCATION	
ASEWORK									
ASEWORK	P1	PAINT	SHERWIN WILLIAMS	VARIES BY CABINET MATERIAL. SEE SPECIFICATIONS.	SW9178 IN THE NAVY	SATIN		EXISTING KITCHEN AND BATHROOM CASEWORK	
SEWORK	SS1	SOLID SURFACE	LG HI-MAC	SOLID SURFACE	RIPE COTTON G518R		30" X 145" SHEETS	KITCHEN, BATHROOM	

	TOILET ACCESSORIES SCHEDULE						
Type Mark	Manufacturer	Model	Description				
МН	BRADLEY	MODEL 781	CHANNEL FRAME MIRROR (18"W x 36"H)				

#### SHEET GENERAL NOTES

- A. TYPICAL UNIT LAYOUT SHOWN. CONTRACTOR TO VERIFY DIMENSIONS AND FIELD CONDITIONS TO CONFIRM CONSTRUCTABILITY. ANY CONFLICTS OR OMISSIONS SHALL BE IMMEDIATELY REPORTED TO THE ARCHITECT FOR CLARIFICATION PRIOR TO THE PERFORMANCE OF WORK. EXACT DEVICE AND FIXTURE LOCATIONS MAY VARY. COORDINATE WITH EXISTING
- CONDITIONS ON A UNIT BY UNIT BASIS. B. WORK NOTED "BY OTHERS" OR "NIC" IS NOT IN CONTRACT. C. WORK OUTSIDE "AREA OF WORK", IS NOT IN CONTRACT, UNLESS
- OTHERWISE NOTED. D. EXISTING WALL SURFACES AND PARTITIONS TO REMAIN SHALL BE
- PATCHED, SPACKLED AND SANDED SMOOTH SO AS NOT TO LEAVE ANY EVIDENCE OF DEMOLITION OR REPAIR WORK. E. PROVIDE OR REUSE HOT AND COLD WATER LINES, SOIL, VENT LINES AND PRESSURE AND SHUTOFF VALVES AS REQUIRED IN
- ACCORDANCE WITH LOCAL BUILDING AND PLUMBING CODES FOR PLUMBING FIXTURES. F. COORDINATE AND PROVIDE FIRE RETARDANT BLOCKING IN PARTITIONS AND CEILING FOR MILLWORK, WALL AND CEILING
- ATTACHED ITEMS. G. DO NOT SCALE DRAWINGS. ALL PARTITION LOCATIONS, DIMENSIONS AND TYPES, DOOR AND WINDOW LOCATIONS SHALL BE AS SHOWN ON PARTITION PLAN. IN CASE OF CONFLICT, NOTIFY ARCHITECT.
- PARTITION PLAN SUPERSEDES OTHER PLANS. H. PARTITIONS ARE DIMENSIONED FROM FINISH FACE TO FINISH FACE, UNLESS OTHERWISE NOTED. DIMENSIONS MARKED "CLEAR" SHALL BE MAINTAINED AND SHALL ALLOW FOR THICKNESS OF FINISHES.

#### SHEET KEYNOTES

**KEY PLAN** 

BUILDINGS I, K

- 01 PRIME AND PAINT EXISTING UPPER AND LOWER CABINET BOXES, FACE FRAMES AND DOORS. INSTALL NEW SOLID SURFACE COUNTER TOP WITH 4" BACKSPLASH.
- 02 BASE BID: REPLACE EXISTING WALL HUNG SINK. ADD ALT 1: INSTALL NEW BASE CABINETS AND SOLID SURFACE TOP WITH NEW UNDERMOUNT SINK. SEE DETAILS 1A/A111.A + 2A/A111.A
- 03 NEW CEILING MOUNTED EXHAUST FAN WITH INTEGRATED LIGHT. 04 NEW SCONCE TO REPLACE EXISTING LOCATION.
- 05 BASE BID: REPLACE EXISTING WALL HUNG SINK. ADD ALT 1: INSTALL NEW BASE CABINETS AND SOLID SURFACE TOP WITH NEW UNDERMOUNT SINK. SEE DETAILS 1A/A111.B + 2A/A111.B



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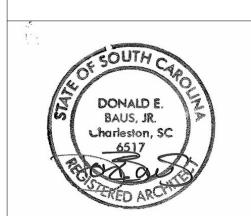
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1 OSE Comments

PROJECT TEAM
PRINCIPAL IN CHARGE
D BAUS

PROJECT MANAGER
S KERSCHEN

Design TEAM
Designer
PROJECT NAME

Village Apartments Interior Renovation, FMU 4822 E Palmetto St Florence, SC 29506 OSE PROJECT NUMBER -H18-N095-SG

PROJECT NO. 4142197600

SHEET TITLE ENLARGED FLOOR PLAN, CEILING PLAN, & ELEVATIONS - 1BR.B -LEVEL 01


A111.B


1D FLOOR PLAN - 1BR.C

A111.C 1/4" = 1'-0"

1C KITCHEN ELEVATION 1 - 1BR.C

A111.C 1/2" = 1'-0"

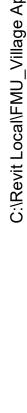

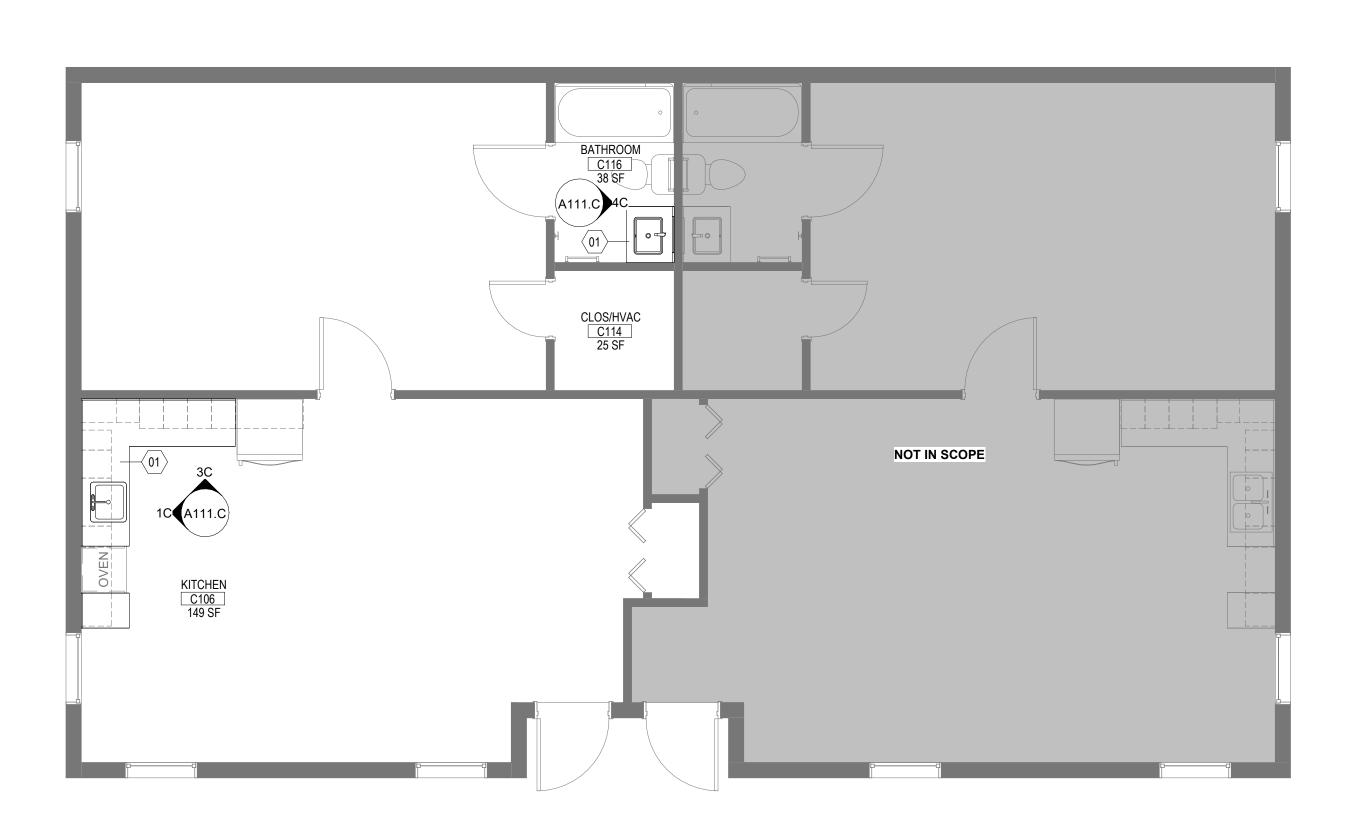


NOT IN SCOPE

AD REFLECTED CEILING PLAN - 1BR.C

1/4" = 1'-0"

SS1 P1 — 3C KITCHEN ELEVATION 2 - 1BR.C

1/2" = 1'-0"

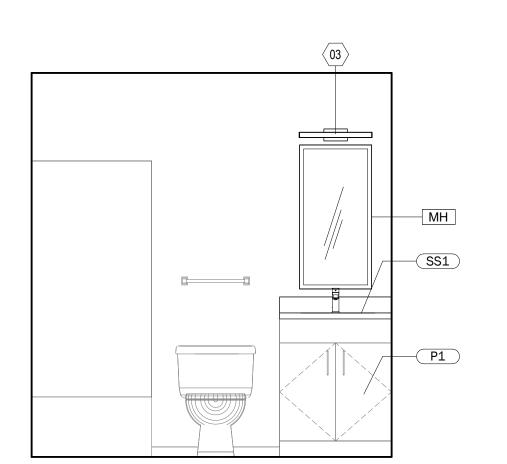

4C BATHROOM ELEVATION, TYP. - 1BR.C

1/2" = 1'-0"

			FI	NISH SCHEDULE				
FINISH CATEGORY	FINISH TYPE & NUMBER	TYPE DESCRIPTION	MANUFACTURER	PRODUCT	COLOR	FINISH	SIZE	LOCATION
CASEWORK								
CASEWORK	P1	PAINT	SHERWIN WILLIAMS	VARIES BY CABINET MATERIAL. SEE SPECIFICATIONS.	SW9178 IN THE NAVY	SATIN		EXISTING KITCHEN AND BATHROOM CASEWORK
CASEWORK	SS1	SOLID SURFACE	LG HI-MAC	SOLID SURFACE	RIPE COTTON G518R		30" X 145" SHEETS	KITCHEN, BATHROOM

		TOILE	T ACCESSORIES SCHEDULE
/pe ark	Manufacturer	Model	Description
1	BRADLEY	MODEL 781	CHANNEL FRAME MIRROR (18"W x 36"H)

## SHEET GENERAL NOTES

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- 02 NEW CEILING MOUNTED EXHAUST FAN WITH INTEGRATED LIGHT. SEE MEP DRAWINGS.
- 03 NEW SCONCE TO REPLACE EXISTING LOCATION. SEE MEP



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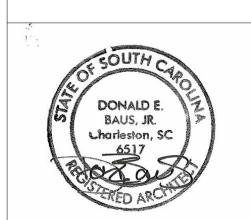
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NO.	REASON	DATE
1	OSE Comments	02.21.2025

PROJECT TEAM

PRINCIPAL IN CHARGE

D BAUS PROJECT MANAGER
S KERSCHEN

Village Apartments Interior Renovation, FMU 4822 E Palmetto St Florence, SC 29506

OSE PROJECT NUMBER -H18-N095-SG PROJECT NO.

4142197600

SHEET TITLE ENLARGED FLOOR PLAN, CEILING PLAN, & ELEVATIONS - 1BR.C

A111.C




(A111.D) BATHROOM

1D FLOOR PLAN - TYP. 4BR.D


A111.D 1/4" = 1'-0"

4D REFLECTED CEILING PLAN - TYP. 4BR.D A111.D 1/4" = 1'-0"

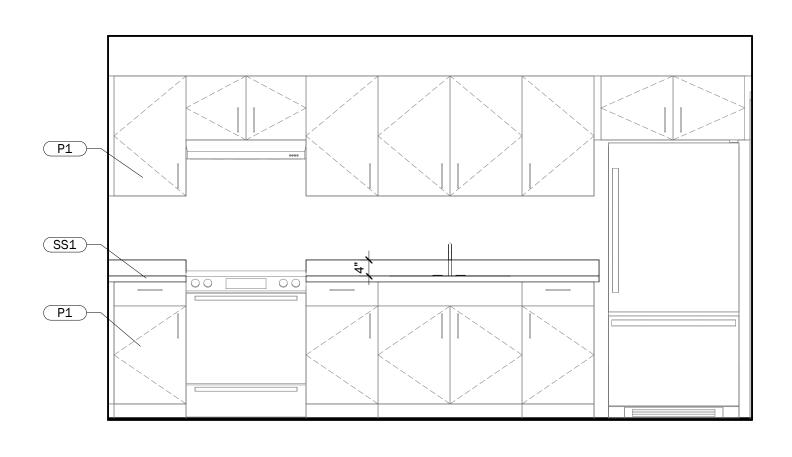

1C KITCHEN ELEVATION - 4BR.D

A111.D 1/2" = 1'-0"

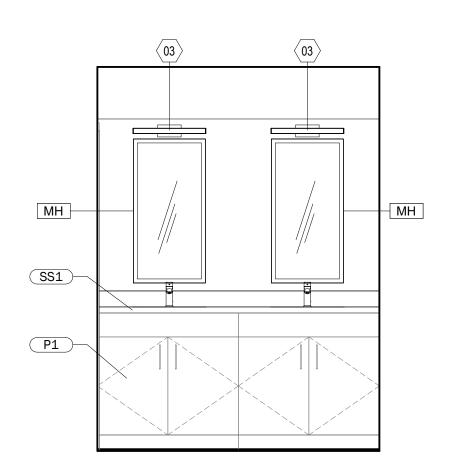

3C BATHROOM ELEVATION - 4BR.D

1/2" = 1'-0"

			FIN	NISH SCHEDULE				
FINISH CATEGORY	FINISH TYPE & NUMBER	TYPE DESCRIPTION	MANUFACTURER	PRODUCT	COLOR	FINISH	SIZE	LOCATION
CASEWORK								
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CASEWORK	SS1	SOLID SURFACE	LG HI-MAC	SOLID SURFACE	RIPE COTTON G518R		30" X 145" SHEETS	KITCHEN, BATHROOM

		TOILE	T ACCESSORIES SCHEDULE
/pe			
ark	Manufacturer	Model	Description
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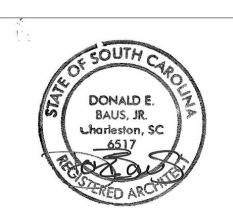
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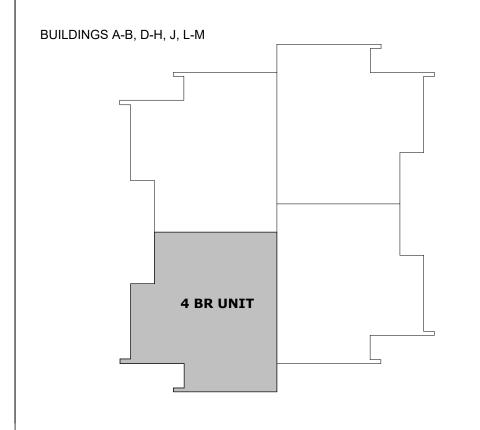
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1 OSE Comments

**KEY PLAN** 



PROJECT TEAM
PRINCIPAL IN CHARGE
D BAUS

PROJECT MANAGER
S KERSCHEN

DESIGN TEAM
Designer
PROJECT NAME

Village Apartments Interior Renovation, FMU

4822 E Palmetto St Florence, SC 29506 OSE PROJECT NUMBER -H18-N095-SG

4142197600

PROJECT NO.

SHEET TITLE ENLARGED FLOOR PLAN, CEILING PLAN, & ELEVATIONS - 4BR.D -LEVEL 01

A111.D

**EXISTING** 

2. ANY ITEMS NOT SHOWN TO BE DEMOLISHED, THAT ARE DAMAGED DURING THE EXECUTION OF THIS WORK SCOPE, SHALL BE REPAIRED BY THE CONTRACTOR.

3. WHERE VENT PIPING IS REMOVED AND NO NEW PIPING IS CONNECTED TO EXISTING VENT-THROUGH-ROOF PENETRATIONS, THE ABANDONED VENT-THROUGH-ROOF SHALL BE CAPPED ABOVE THE ROOF AND BELOW THE ROOF IN THE CEILING SPACE. THIS VERTICAL PIPE SHALL BE SECURED TO STRUCTURE IN AN APPROVED MANNER. ALL PIPING CAPS SHALL BE WATER AND GAS TIGHT CONNECTIONS IN A PERMANENT PIPING ARRANGEMENT.

4. NEW REPLACEMENT FIXTURES SHALL TIE IN TO EXISTING PIPING IF PIPE SIZING MEETS CODE MINIMUM SIZES. NEW FIXTURES INSTALLED WHERE NONE ARE EXISTING SHALL MEET SCHEDULED PIPE REQUIREMENTS.

5. THESE DRAWINGS ARE BASED ON FIELD OBSERVATIONS AND EXISTING DRAWINGS PROVIDED TO THE A/E BY THE OWNER. THE DRAWINGS ARE FROM PREVIOUS PROJECT(S), WHEN AVAILABLE. FIELD OBSERVATIONS, HOWEVER, PROVIDED LITTLE DATA, AS MOST OF THE INSTALLATIONS WERE INACCESSIBLE FOR VISUAL CONFIRMATION. THE INTENT OF THESE DRAWINGS IS TO PROVIDE AS MUCH INFORMATION TO THE CONTRACTOR AS POSSIBLE. HOWEVER, IT IS THE CONTRACTOR'S RESPONSIBILITY TO CONFIRM ACTUAL FIELD CONDITIONS AND INFORMATION PROVIDED HEREIN.

6. AS EXISTING PIPING IS ENCOUNTERED, THE CONTRACTOR SHALL ASSESS THE CONDITION OF THE PIPING BEFORE TIE-INS ARE MADE. IF THE PIPING IS BELIEVED TO BE IN POOR CONDITION OR NOT ADEQUATE FOR USE AS INTENDED, THE CONTRACTOR SHALL IMMEDIATELY REPORT SUCH TO THE A/E. TIE-INS ARE NOT TO PROCEED UNTIL CONTRACTOR HAS RECEIVED A RESPONSE FROM

7. WHEN CONSTRUCTION IS COMPLETE, CONTRACTOR SHALL THOROUGHLY CLEAN ALL FIXTURES, EQUIPMENT AND SYSTEMS BEFORE PLACING IN OPERATION OR TURN OVER TO THE OWNER. RESTORE FINISHED SURFACES IF DAMAGED AND DELIVER THE ENTIRE INSTALLATION IN AN APPROVED CONDITION.

8. ADEQUATE PROTECTION SHALL BE PROVIDED FOR THE BUILDING(S) AND CONTENTS DURING THE PERFORMANCE OF THE WORK. TRASH REMOVAL SHALL BE PERFORMED DAILY AND COORDINATED WITH THE OWNER'S REPRESENTATIVE TO PREVENT IT'S ACCUMULATION, TO ENSURE PROPER DISPOSAL OF MATERIALS, AND TO PROTECT THE PROPERTY. CONTRACTOR SHALL CONTROL DUST AND DEBRIS TO PREVENT SPREAD INTO THE BUILDING(S).

9. NEATLY CORE-DRILL AND/OR SAW-CUT FLOORS, WALLS, SIDEWALKS AND PAVING AS REQUIRED. INSTALL NEW FIXTURES AND APPROPRIATE PIPING AND REPAIR FINISHES TO MATCH EXISTING. CORE-DRILL AND/OR SAW-CUT HOLES AND SLOTS AS SMALL AS POSSIBLE. DO NOT CUT BUILDING ELEMENTS WITHOUT PRIOR WRITTEN APPROVAL OF THE OWNER OR AUTHORIZED REPRESENTATIVE.

5

				PLUM	IBING FIX	TURE	SC	HEDL	JLE		
MADK	FIXTURE	MANUFACTURER	MODEL	FAUCET	/VALVE		CONN	ECTIONS		DESCRIPTION	REMARKS
MAINI	TIXTORE	WAITO ACTORER	WIODEL	MANUFACTURER	MODEL	CW	HW	WASTE	VENT	BESOMI HON	KLINAKKO
L-1	LAVATORY - BATHROOM (1BR.C, 4BR.D, 1BR.AB ADD ALT)	AMERICAN STANDARD	0614.000	ZURN	AQUASPEC Z82200-XL-3M	1/2"	1/2"	2"	1-1/2"	WHITE VITREOUS CHINA, UNDERMOUNT LAVATORY, MANUAL OPERATED FAUCET, POLISHED CHROME PLATED CAST BRASS SINGLE LAVATORY FAUCET WITH WATER SAVING AERATOR AND McGUIRE "PROWRAP" MODEL PW2150WC OFF-SET WASTE, P-TRAP, GRID WASTE AND SUPPLIES ALL COATED WITH SEAMLESS ANTI-MICROBIAL PIPE INSULATOR MADE OF PVC RESIN.	HANDICAP TYPE
L-2	LAVATORY - BATHROOM (1BR.AB)	ZURN	Z5350	ZURN	AQUASPEC Z82200-XL-3M	1/2"	1/2"	2"		WHITE VITREOUS CHINA, WALL MOUNTED SINK WITH CARRIER, SINGLE HOLE SINK, MANUAL OPERATED FAUCET, POLISHED CHROME PLATED CAST BRASS SINGLE LAVATORY FAUCET WITH WATER SAVING AERATOR AND McGUIRE "PROWRAP" MODEL PW2150WC OFF-SET WASTE, P-TRAP, GRID WASTE AND SUPPLIES ALL COATED WITH SEAMLESS ANTI-MICROBIAL PIPE INSULATOR MADE OF PVC RESIN.	HANDICAP TYPE
S-1	KITCHEN SINK (1BR.AB, 1BR.C)	ELKAY	HDU24189F	ELKAY	LK1501CR	1/2"	1/2"	2"	1-1/2"	STAINLESS STEEL 24"x18"x9" SINGLE COMPARTMENT SINK, MANUAL OPERATED FAUCET, POLISHED CHROME PLATED, PROVIDE LK35L DRAIN, COMMERCIAL GRADE HEAVY PATTERN STOPS, 17 GAUGE P-TRAP, ADA COMPLIANT. PROVIDE WITH McGUIRE "PROWRAP" MODEL PW2150WC OFF-SET WASTE WITH P-TRAP AND SUPPLIES ALL COATED WITH SEAMLESS ANTI-MICROBIAL PIPE INSULATOR MADE OF PVC RESIN.	HANDICAP TYPE
S-2	KITCHEN SINK (4BR.D)	ELKAY	HDU32189F	ELKAY	LK1501CR	1/2"	1/2"	2"	1-1/2"	STAINLESS STEEL 31"x18"x9" SINGLE COMPARTMENT SINK, MANUAL OPERATED FAUCET, POLISHED CHROME PLATED, PROVIDE LK35L, COMMERCIAL GRADE HEAVY PATTERN STOPS, 17 GAUGE P-TRAP, ADA COMPLIANT. PROVIDE WITH McGUIRE "PROWRAP" MODEL PW2150WC OFF-SET WASTE WITH P-TRAP AND SUPPLIES ALL COATED WITH SEAMLESS ANTI-MICROBIAL PIPE INSULATOR MADE OF PVC RESIN.	HANDICAP TYPE

**VALVES AND ACCESSORIES** 

BALL VALVE

CAPPED PIPE

CHECK VALVE

CONCENTRIC REDUCER

DIRECTION OF FLOW

ECCENTRIC REDUCER

FLANGED CONNECTION

FLEXIBLE CONNECTION

GATE VALVE

GLOBE VALVE

GAS COCK

PIPE SLEEVE

 $\longrightarrow$ 

+

MANUAL AIR VENT

W/PRESSURE TAPS

METERED BALANCING VALVE

PRESSURE REDUCING VALVE

PRESSURE GAUGE WITH GAUGE COCK

STRAINER W/BLOW DOWN VALVE

PRESSURE RELIEF VALVE

SQUARE HEAD COCK

**THERMOMETER** 

VACUUM BREAKER

SOLENOID VALVE

AUTOMATIC AIR VENT

AUTOMATIC FLOW CONTROL VALVE

BACKFLOW PREVENTER (BFP)

					FAN S	CHEDUL	-E							
				FAI	N CHARACTERIS	STICS			ELEC	TRICAL DATA				
MARK	SERVICE	TYPE	AIRFLOW (CFM)	ESP	INPUT (kW)	RPM	SONES	VOLTAGE	PHASE	FREQUENCY	FLA	WEIGHT	MANUFACTURER	MODEL
EF-1	RESTROOMS (1BR.AB & 1BR.C)	CEILING EXHAUST FAN	100	0.25 in-wg	11	939	1.5	115 V	1	60 Hz	0.29 A	8 lb	GREENHECK	SP-LP0810WL
EF-2	RESTROOMS (4BR.D)	CEILING EXHAUST FAN	50	0.25 in-wg	7	748	0.5	115 V	1	60 Hz	0.29 A	8 lb	GREENHECK	SP-LP0810WL

1. PROVIDE EXHAUST FAN WITH GRAVITY BACK DRAFT DAMPER. 2. PROVIDE FAN WITH SPEED CONTROLLER.

3. PROVIDE FAN WITH NEMA RATED DISCONNECT.

4. MOTOR SHALL BE OPEN DRIP PROOF WITH PERMANENTLY LUBRICATED SEALED BEARINGS AND BUILT IN THERMAL OVERLOAD.

5. FAN SHALL BE CONTROLLED BY LIGHT SWITCH. REFER TO ELECTRICAL DRAWINGS.

6. FURNISHED / INSTALLED / WARRANTED BY MECHANICAL CONTRACTOR.

#### GENERAL NOTES

- 1. ALL WORK SHALL CONFORM TO THE CURRENTLY ADOPTED PLUMBING CODE EDITION AND ALL LOCAL CODES, AMENDMENTS, RULES AND REGULATIONS INCLUDING THE AMERICANS WITH DISABILITIES ACT (ADA) ACCESSIBILITY GUIDELINES, OSHA ACTS AND REGULATIONS, AND THE REQUIREMENTS OF THE LOCAL AUTHORITIES HAVING JURISDICTION.
- 2. OPENINGS THRU WALLS, FLOORS AND ROOFS SHALL BE FLASHED AND SEALED WATER TIGHT. PENETRATIONS THROUGH SMOKE OR FIRE-RATED WALLS AND/OR PARTITIONS SHALL BE SEALED TO MAINTAIN RATING PER ASTM E-814 AND BUILDING CODE
- 3. INTERRUPTIONS OF SERVICES SHALL BE COORDINATED WITH THE OWNER AND OTHER TRADES AT LEAST 48 HOURS IN ADVANCE OF THE WORK BEING PERFORMED. DISRUPTION TIME SHALL BE KEPT TO A MINIMUM.
- 4. UNLESS OTHERWISE INDICATED, ALL PIPING SHALL BE RUN IN CONCEALED SPACES IN WALLS, IN CHASES OR BETWEEN CEILINGS AND INSULATION ABOVE. PIPES SHALL BE RUN AT RIGHT ANGLES OR PARALLEL LINES WITH BUILDING WALLS AND ROUTED WITH STRUCTURAL MEMBERS IN EXPOSED AREAS. PLUMBING SHALL COORDINATE WITH MECHANICAL DUCTWORK IN ALL CHASES. SUPPORT ALL INTERIOR PIPING FROM BUILDING STRUCTURE BY MEANS OF PIPE STANDS, HANGERS OR INSERTS TO MAINTAIN REQUIRED GRADING AND PITCHING OF LINES, TO PREVENT VIBRATION AND TO SECURE PIPING IN PLACE. SOIL WASTE AND VENT STACKS SHALL BE SUPPORTED AT THE BASE BY MEANS OF PIERS OR HEAVY-DUTY RISER CLAMPS CLOSE TO THE BOTTOM OF RISERS AND SECURED AT EACH FLOOR BY MEANS OF HEAVY-DUTY IRON RISER CLAMPS. PROTECT COPPER PIPING AGAINST CONTACT WITH MASONRY OR DISSIMILAR METALS. COPPER PIPING HANGERS, SUPPORTS, ANCHORS AND CLIPS SHALL BE COPPER OR COPPER PLATED. PROVIDE CLEANOUTS AT THE BASE OF EACH WASTE OR INTERIOR STORM DRAINAGE STACK. WCO AND COP AT BASE OF STACKS SHALL BE 12" TO 15" AFF. FLAT WALL CLEANOUT COVERS SHALL BE FLUSH WITH FINISHED WALL SURFACE. DEEP COVERS ARE NOT ACCEPTABLE. EXPOSED PIPING SHALL BE LABELED WITH SERVICE AND DIRECTION OF FLOW EVERY 20 FEET, AND IN EACH ROOM. ALL VALVES SHALL BE TAGGED. EXPOSED PIPING CONNECTIONS IN OCCUPIED SPACES SHALL BE CHROME PLATED.
- 5. IT SHALL BE THE RESPONSIBILITY OF THE CONTRACTOR TO VERIFY THE ITEMS TO BE FURNISHED FIT THE SPACE AVAILABLE. CONTRACTOR TO VERIFY LOCATIONS OF ALL SERVICES AND CONNECTION POINTS. CONTRACTOR SHALL FIELD CONFIRM ALL PIPE SIZES AND LOCATIONS, AND ALL DIMENSIONS AND ELEVATIONS. CONTRACTOR SHALL BE RESPONSIBLE FOR CONTACTING AND PAYING ALL FEES FOR UTILITY LOCATOR SERVICE TO LOCATE PUBLIC AND PRIVATE UTILITIES AND UNDERGROUND STRUCTURES BEFORE DIGGING. CONTRACTOR SHALL BE RESPONSIBLE FOR ANY DAMAGES INCURRED AS A RESULT OF THIS WORK. ALL DISCOVERIES SHALL BE ACCURATELY SHOWN ON THE RECORD DRAWINGS.
- 6. THE DRAWINGS ARE INTENDED TO COVER THE COMPLETE PLUMBING SYSTEMS. HOWEVER, THE DRAWINGS MAY NOT SHOW COMPLETE OR ACCURATE DETAILS OF THE BUILDING OR SYSTEMS IN EVERY RESPECT. IT IS THE RESPONSIBILITY OF THE CONTRACTOR TO CONFIRM FIELD CONDITIONS AND OBTAIN ANY ADDITIONAL INFORMATION AS REQUIRED. DO NOT SCALE FROM CONTRACT DRAWINGS.
- 7. THE ENGINEER SHALL NOT BE RESPONSIBLE FOR THE MEANS, METHODS, TECHNIQUES, SEQUENCES OR PROCEDURES OF CONSTRUCTION SELECTED BY THE CONTRACTOR OR OF THE SAFETY PRECAUTIONS AND PROGRAMS INCIDENTAL TO THE WORK OF THE CONTRACTOR TO PERFORM THE CONSTRUCTION WORK IN ACCORDANCE WITH OSHA, APPLICABLE CODES, THE DRAWINGS
- 8. PROVIDE DIELECTRIC UNIONS OR OTHER NON-CONDUCTIVE MEANS TO PREVENT ELECTROLYSIS.
- 9. SANITARY TIE-INS SHALL BE MADE WITH SANITARY TEES IN THE VERTICAL AND WYES IN THE HORIZONTAL. SANITARY PIPE CONNECTIONS SHALL NOT BE REDUCED IN SIZE WITHOUT PRIOR APPROVAL OF THE A/E.
- 10. ALL DISCONNECT SWITCHES, MOTOR STARTERS ASSOCIATED WITH DIVISION 22 EQUIPMENT SHALL BE FURNISHED BY THE DIVISION 22 CONTRACTOR AS APPLICABLE. WHERE COMBINATION MOTOR STARTERS ARE PROVIDED WITH INPUT POWER DISCONNECT SWITCH WITH OPERABLE HANDLE, A SEPARATE DISCONNECT SWITCH AT MOTOR STARTER IS NOT REQUIRED. COORDINATE ELECTRICAL POWER REQUIREMENTS OF ALL DIVISION EQUIPMENT WITH DIVISION 26 CONTRACTOR FOR DISCONNECT SWITCHES, MOTOR STARTERS, FEEDER BREAKER AND CABLE SIZE TO BE ACCURATE PER EQUIPMENT NAMEPLATE DATA. REFER TO ELECTRICAL SPECIFICATIONS FOR ELECTRICAL DEVICES SPECIFICATIONS. VFD'S FOR DIVISION 22 WILL BE PROVIDED BY THIS DIVISION CONTRACTOR IN ACCORDANCE WITH DIVISION 26 REQUIREMENTS.
- 11. CONTRACTOR SHALL INSTALL FIXTURES, EQUIPMENT AND MATERIALS IN ACCORDANCE WITH THE MANUFACTURER'S WRITTEN INSTRUCTIONS, AND APPLICABLE CODES. INSTALL ADA FIXTURES AT THE HEIGHTS PRESCRIBED BY THE CODE HAVING JURISDICTION. MAKE PROPER PIPING CONNECTIONS TO FIXTURES AND EQUIPMENT EVEN THOUGH BRANCH MAINS, ELBOWS AND CONNECTIONS ARE NOT SHOWN. COORDINATE WITH ARCHITECTURAL DRAWINGS BEFORE ROUGHING-IN PLUMBING FIXTURES. PROVIDE STOPS ON ALL PLUMBING FIXTURE WATER SUPPLIES. SENSOR OPERATED FLUSH VALVES SHALL BE MOUNTED AT A HEIGHT WHEREAS RAISED WATER CLOSET SEATS SHALL NOT INTERFERE WITH FLUSH VALVE OPERATION.
- 12. CENTER OF FLOOR DRAINS RECEIVING DRAINAGE FROM BFP TEST PORTS, T&P RELIEF VALVE DISCHARGES AND OTHER CLEAR WATER WASTES SHALL BE LOCATED WITHIN 12" OF ITEMS OF EQUIPMENT, EQUIPMENT PADS OR ADJACENT WALLS. PIPES ROUTED TO THESE FLOOR DRAINS SHALL BE ROUTED IN SUCH A WAY AS TO NOT CAUSE A TRIPPING HAZARD.
- 13. PROVIDE 4" HIGH (MIN.) CONCRETE HOUSEKEEPING PADS FOR ALL FLOOR MOUNTED EQUIPMENT, PAD SHALL BE A MINIMUM OF 6" LARGER IN ALL DIRECTIONS THAN THE EQUIPMENT
- 14. LOCATE ALL VALVES ABOVE ACCESSIBLE CEILING WHERE POSSIBLE. PROVIDE ACCESS DOORS FOR ALL CONCEALED VALVES IN INACCESSIBLE LOCATIONS.
- 15. INSTALL EQUIPMENT TO FACILITATE SERVICING, MAINTENANCE, AND REPAIR OR REPLACEMENT OF EQUIPMENT COMPONENTS. AS MUCH AS PRACTICAL, CONNECT EQUIPMENT FOR EASE OF DISCONNECTING, WITH A MINIMUM OF INTERFERENCE WITH OTHER INSTALLATIONS. PIPING SHALL NOT INTERFERE WITH COMPONENT CLEARANCES. UNIONS AND/OR FLANGES SHALL BE INSTALLED AT EACH PIECE OF EQUIPMENT TO PERMIT DISASSEMBLY FOR ALTERATION AND REPAIRS. PROVIDE FLEXIBLE CONNECTIONS IN PIPING SYSTEMS CONNECTED TO PUMPS AND OTHER EQUIPMENT REQUIRING VIBRATION ISOLATION AS CLOSE TO EQUIPMENT AS POSSIBLE, UNLESS SHOWN OTHERWISE ON DRAWINGS.
- 16. ANY ITEMS THAT ARE DAMAGED, SHALL BE REPAIRED BY THE CONTRACTOR.
- 17. ALL PIPING CAPS SHALL BE WATER AND GAS TIGHT CONNECTIONS IN A PERMANENT PIPING ARRANGEMENT.
- 18. NEW FIXTURES INSTALLED SHALL MEET SCHEDULED PIPE REQUIREMENTS.
- 19. P.C. SHALL BALANCE HOT WATER RETURN SYSTEM TO INSURE ADEQUATE FLOW OF HOT WATER TO EACH FIXTURE REQUIRING HOT WATER, PER PLAN(S).
- 20. CONTRACTOR SHALL COORDINATE HIS/HER WORK WITH THAT OF OTHER TRADES.
- 21. THE CONTRACTOR SHALL MAKE A PERSONAL INSPECTION OF THE SITE AND INCLUDE PERFORMING ALL WORK REQUIRED BY THE DRAWINGS AND SPECIFICATIONS. FIELD VERIFY INFORMATION PROVIDED ON THE DRAWINGS AND EXISTING CONDITIONS, INCLUDING: LOCATIONS, ELEVATIONS, DIMENSIONS AND QUANTITIES REQUIRED FOR THE WORK. NOTIFY A/E IN WRITING OF ANY ADDITIONAL WORK THAT MAY BE REQUIRED TO ACCOMPLISH THE SCOPE OF WORK AND/OR ACCOMMODATE FIELD INCONSISTENCIES WITH OR IN THE DRAWINGS AND/OR SPECIFICATIONS.
- 22. WHEN CONSTRUCTION IS COMPLETE, CONTRACTOR SHALL THOROUGHLY CLEAN ALL FIXTURES, EQUIPMENT AND SYSTEMS BEFORE PLACING IN OPERATION OR TURN OVER TO THE OWNER. RESTORE FINISHED SURFACES IF DAMAGED AND DELIVER THE ENTIRE INSTALLATION IN AN APPROVED CONDITION.
- 23. ADEQUATE PROTECTION SHALL BE PROVIDED FOR THE BUILDING(S) AND CONTENTS DURING THE PERFORMANCE OF THE WORK. CONTRACTOR SHALL BE RESPONSIBLE AS TO NOT TO ALLOW ON-SITE ACCUMULATION OF DEBRIS OR DEMOLISHED MATERIALS. HE/SHE SHALL PROMPTLY AND LEGALLY TRANSPORT AND DISPOSE OF MATERIALS OFF-SITE. TRASH REMOVAL SHALL BE PERFORMED DAILY AND COORDINATED WITH THE OWNER'S REPRESENTATIVE TO PREVENT IT'S ACCUMULATION, TO ENSURE PROPER DISPOSAL OF MATERIALS, AND TO PROTECT THE PROPERTY. CONTRACTOR SHALL CONTROL DUST AND DEBRIS TO PREVENT SPREAD INTO THE BUILDING(S). DO NOT BURN DEBRIS OR DEMOLISHED MATERIALS. ALL DISPOSAL COSTS TO BE BORNE
- 24. FOR ALL INVERT ELEVATIONS, FINISHED FLOORS SHALL BE ASSUMED TO BE 0'-0"
- 25. UNLESS OTHERWISE NOTED ON PLANS ALL HOT WATER SUPPLY 140°.
- 26. THIS CONTRACTOR TO BE RESPONSIBLE FOR ALL LOW VOLTAGE WIRING.




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CONSTRUCTION

DOCUMENTS

02/14/2025

1 OSE Comments

PROJECT TEAM

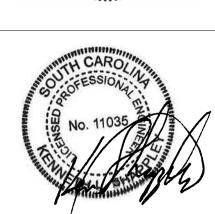DON BAUS PROJECT MANAGER

SYDNEY KERSCHEN


VILLAGE APARTMENTS INTERIOR RENOVATION, 4822 E. PALMETTO ST, FLORENCE, SC 29506

OSE PROJÉCT NUMBER -

PROJECT NO. 414.21976.00

H18-N095-SG

SHEET TITLE MECHANICAL & PLUMBING COVER SHEET & SCHEDULES

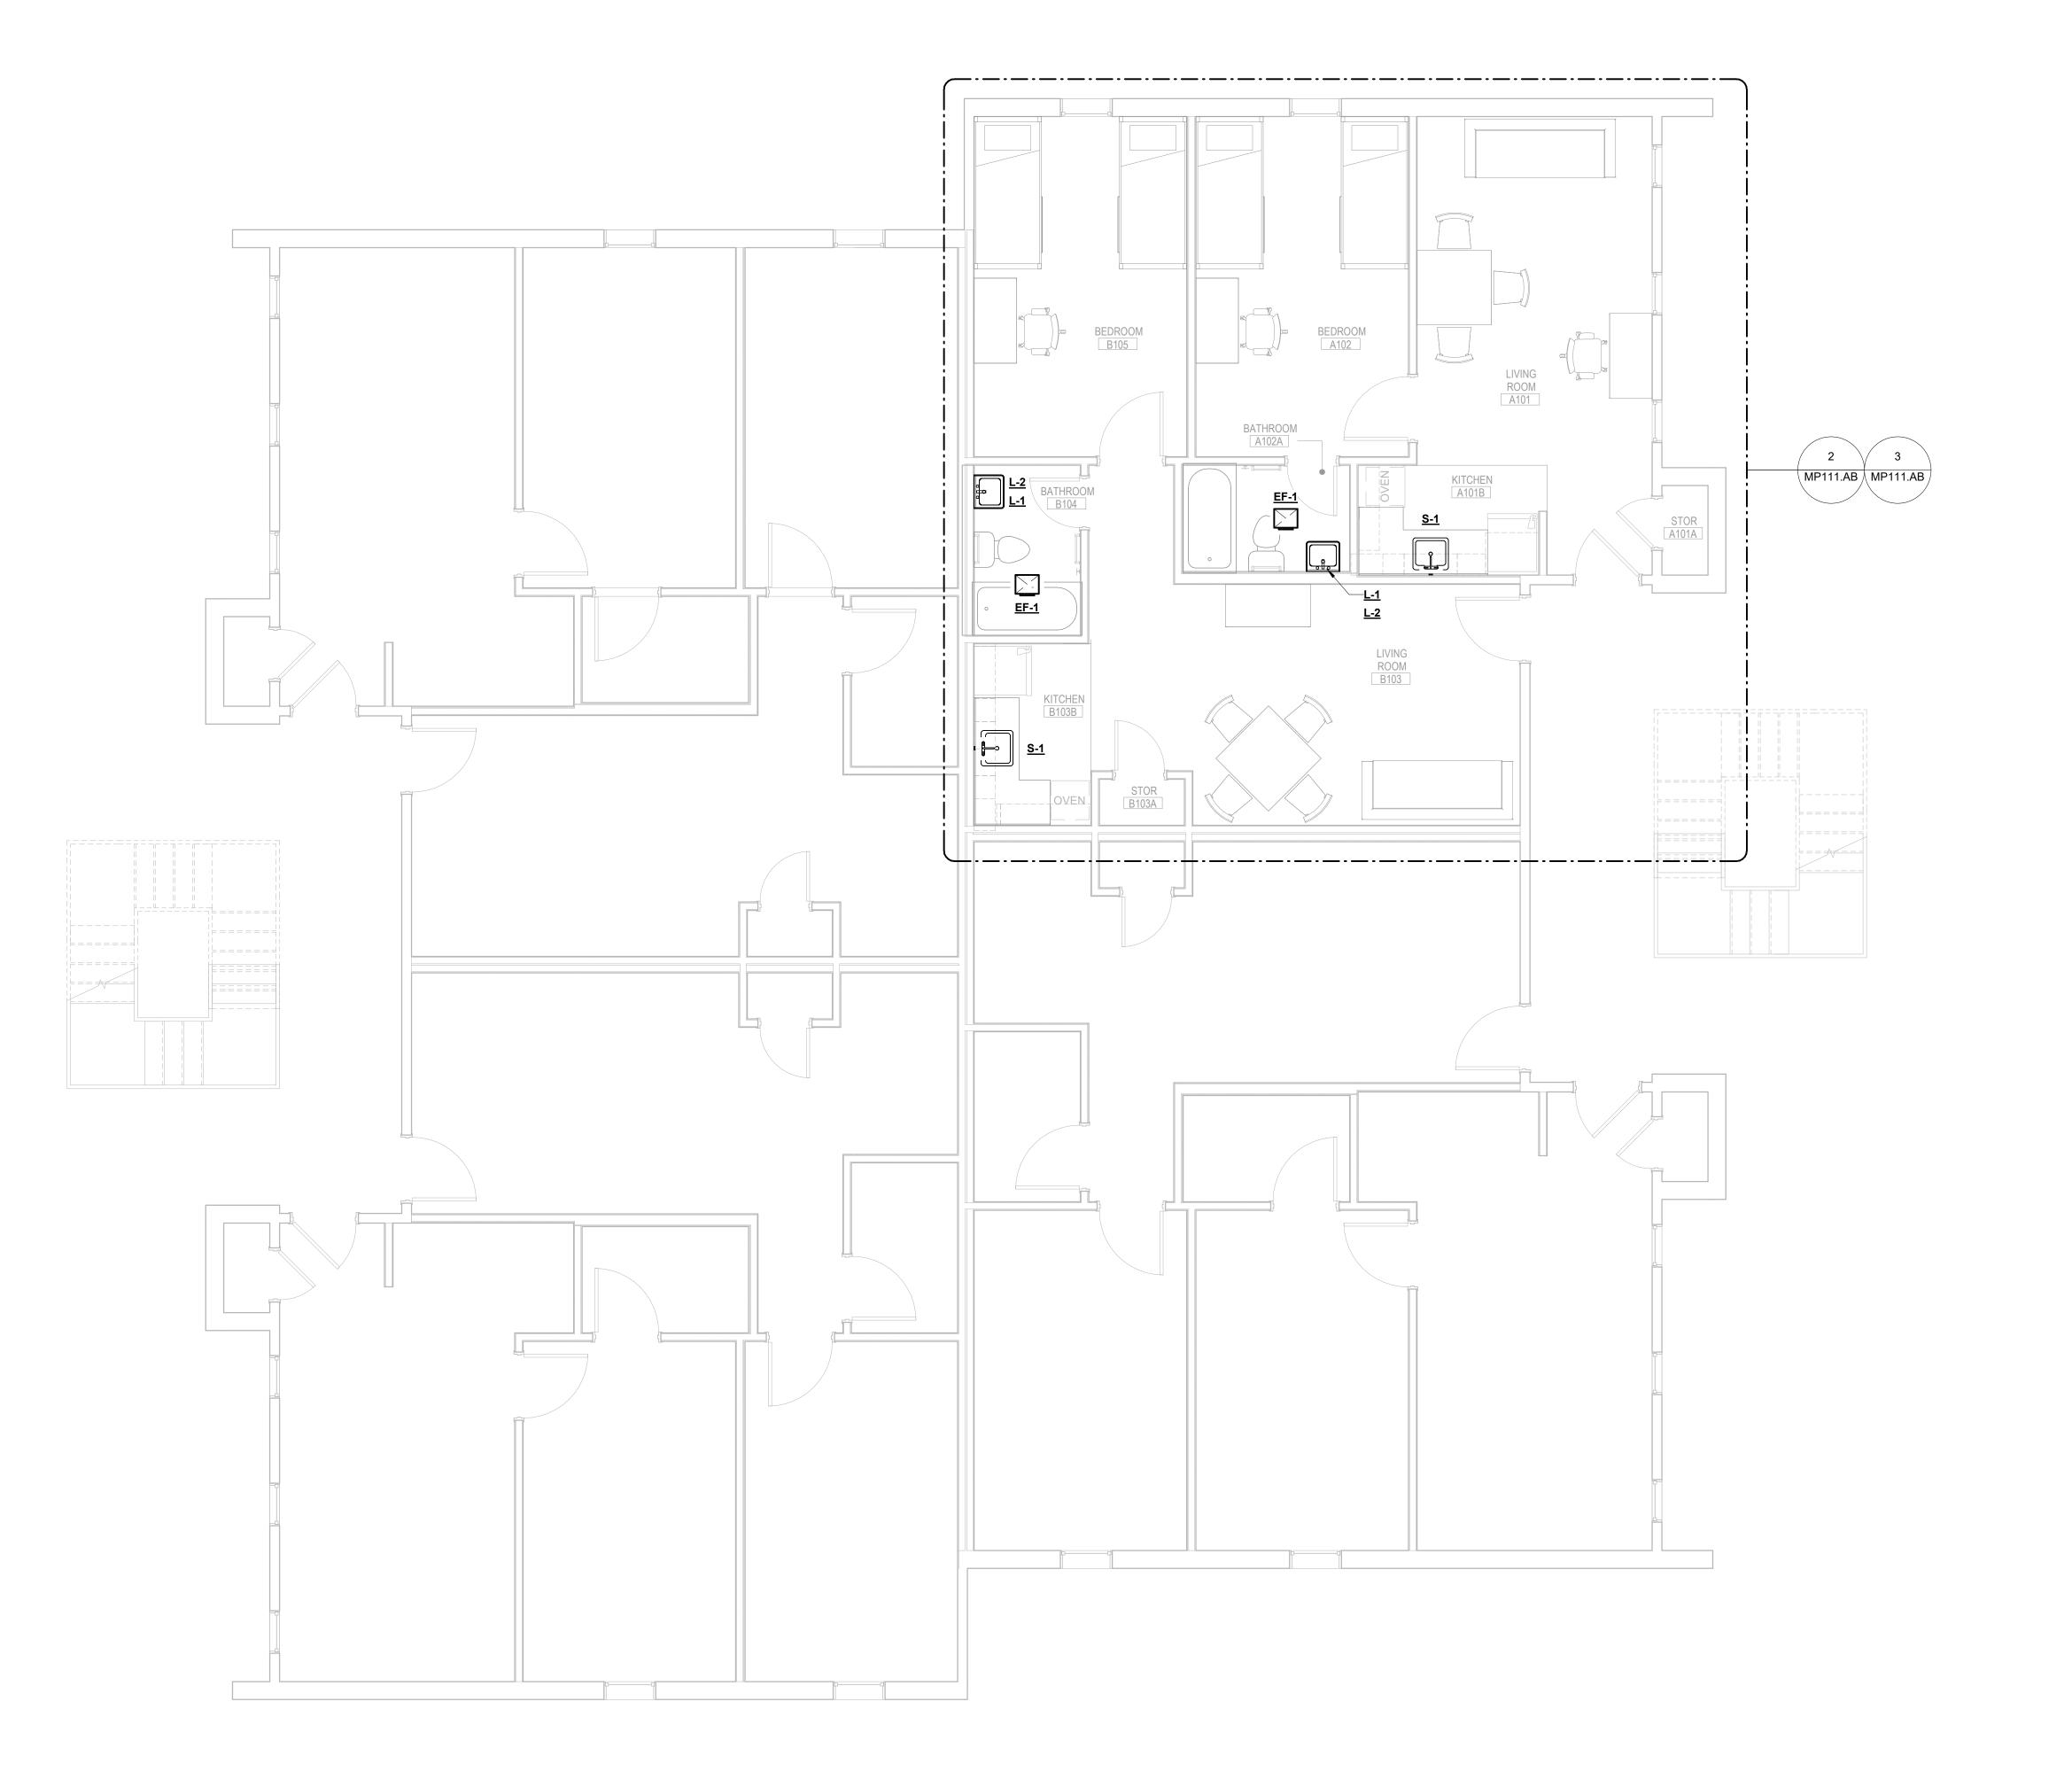

1 MECHANICAL & PLUMBING OVERALL FLOOR PLAN - 1BR.AB - LEVEL 01

MP101.AB 1/4" = 1'-0"

GENERAL SHEET NOTES

- A. SEE SHEET MP001 FOR LEGEND AND GENERAL NOTES.
- B. ALL SYMBOLS ON SHEET MP001 ARE NOT NECESSARILY USED ON THIS PROJECT.
- C. PIPE RUNOUTS TO FIXTURES ARE AS SCHEDULED UNLESS NOTED
- D. INCLUDE ALL CUTTING/PATCHING OF EXISTING SLAB. OBTAIN WRITTEN APPROVAL FROM THE LANDLORD/OWNER PRIOR TO CUTTING/PATCHING.
- E. DRAWINGS WERE PREPARED BASED ON NON-DESTRUCTIVE FIELD WORK. EXISTING PIPING SHOWN ON PLANS IS SCHEMATIC AND MAY NOT NECESSARILY REPRESENT EXACT LOCATIONS. THE CONTRACTOR SHALL VISIT THE SITE PRIOR TO BIDDING TO VERIFY EXISTING UTILITIES. NO ADDITIONAL COST ARE TO BE BORNE BY THE OWNER AS A RESULT OF UTILITY CONFIGURATION DISCREPANCIES THAT WOULD BE REASONABLY DETECTED AS A RESULT OF THIS PRE
- F. TYPICAL UNIT LAYOUT SHOWN. CONTRACTOR TO FIELD VERIFY CONDITIONS IN EACH UNIT AND NOTIFY ARCHITECTURAL TEAM IF SIGNIFICANT VARIATIONS EXIST, BEFORE PROCEEDING WITH WORK. EXACT DEVICE AND FIXTURE LOCATIONS MAY VARY. COORDINATE WITH EXISTING CONDITIONS ON A UNIT BY UNIT BASIS.

**KEY PLAN** 

1 BR UNIT A

(MIRROR)

1 BR UNIT A

UNIT B (MIRROR)


1 BR UNIT B

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BID SITE VISIT.





PROJECT TEAM
PRINCIPAL IN CHARGE
DON BAUS

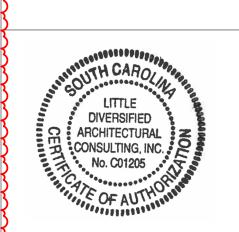1 BR UNIT A

1 BR UNIT A

(MIRROR)

1 BR UNIT B

1 BR UNIT B (MIRROR)

PROJECT MANAGER
SYDNEY KERSCHEN

VILLAGE APARTMENTS INTERIOR RENOVATION, 4822 E. PALMETTO ST, FLORENCE, SC 29506 OSE PROJECT NUMBER -

H18-N095-SG

414.21976.00

SHEET TITLE MECHANICAL & PLUMBING OVERALL FLOOR PLAN -1BR.AB - LEVEL 01

MP101.AB

## GENERAL SHEET NOTES

- A. SEE SHEET MP001 FOR LEGEND AND GENERAL NOTES.
- B. ALL SYMBOLS ON SHEET MP001 ARE NOT NECESSARILY USED ON THIS PROJECT.
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- D. INCLUDE ALL CUTTING/PATCHING OF EXISTING SLAB. OBTAIN WRITTEN APPROVAL FROM THE LANDLORD/OWNER PRIOR TO CUTTING/PATCHING.
- E. DRAWINGS WERE PREPARED BASED ON NON-DESTRUCTIVE FIELD WORK. EXISTING PIPING SHOWN ON PLANS IS SCHEMATIC AND MAY NOT NECESSARILY REPRESENT EXACT LOCATIONS. THE CONTRACTOR SHALL VISIT THE SITE PRIOR TO BIDDING TO VERIFY EXISTING UTILITIES. NO ADDITIONAL COST ARE TO BE BORNE BY THE OWNER AS A RESULT OF UTILITY CONFIGURATION DISCREPANCIES THAT WOULD BE REASONABLY DETECTED AS A RESULT OF THIS PRE BID SITE VISIT.
- F. TYPICAL UNIT LAYOUT SHOWN. CONTRACTOR TO FIELD VERIFY CONDITIONS IN EACH UNIT AND NOTIFY ARCHITECTURAL TEAM IF SIGNIFICANT VARIATIONS EXIST, BEFORE PROCEEDING WITH WORK. EXACT DEVICE AND FIXTURE LOCATIONS MAY VARY. COORDINATE WITH EXISTING CONDITIONS ON A UNIT BY UNIT BASIS.

**KEY PLAN** 

4 BR UNIT

(MIRROR)

4 BR UNIT



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CONSTRUCTION DOCUMENTS

1 OSE Comments

PROJECT TEAM
PRINCIPAL IN CHARGE
DON BAUS

4 BR UNIT

4 BR UNIT

(MIRROR)

PROJECT MANAGER
SYDNEY KERSCHEN


VILLAGE APARTMENTS INTERIOR RENOVATION,

4822 E. PALMETTO ST, FLORENCE, SC 29506 OSE PROJECT NUMBER -

H18-N095-SG 414.21976.00

SHEET TITLE MECHANICAL & PLUMBING OVERALL FLOOR PLAN -4BR.D - LEVEL 01

MP101.D

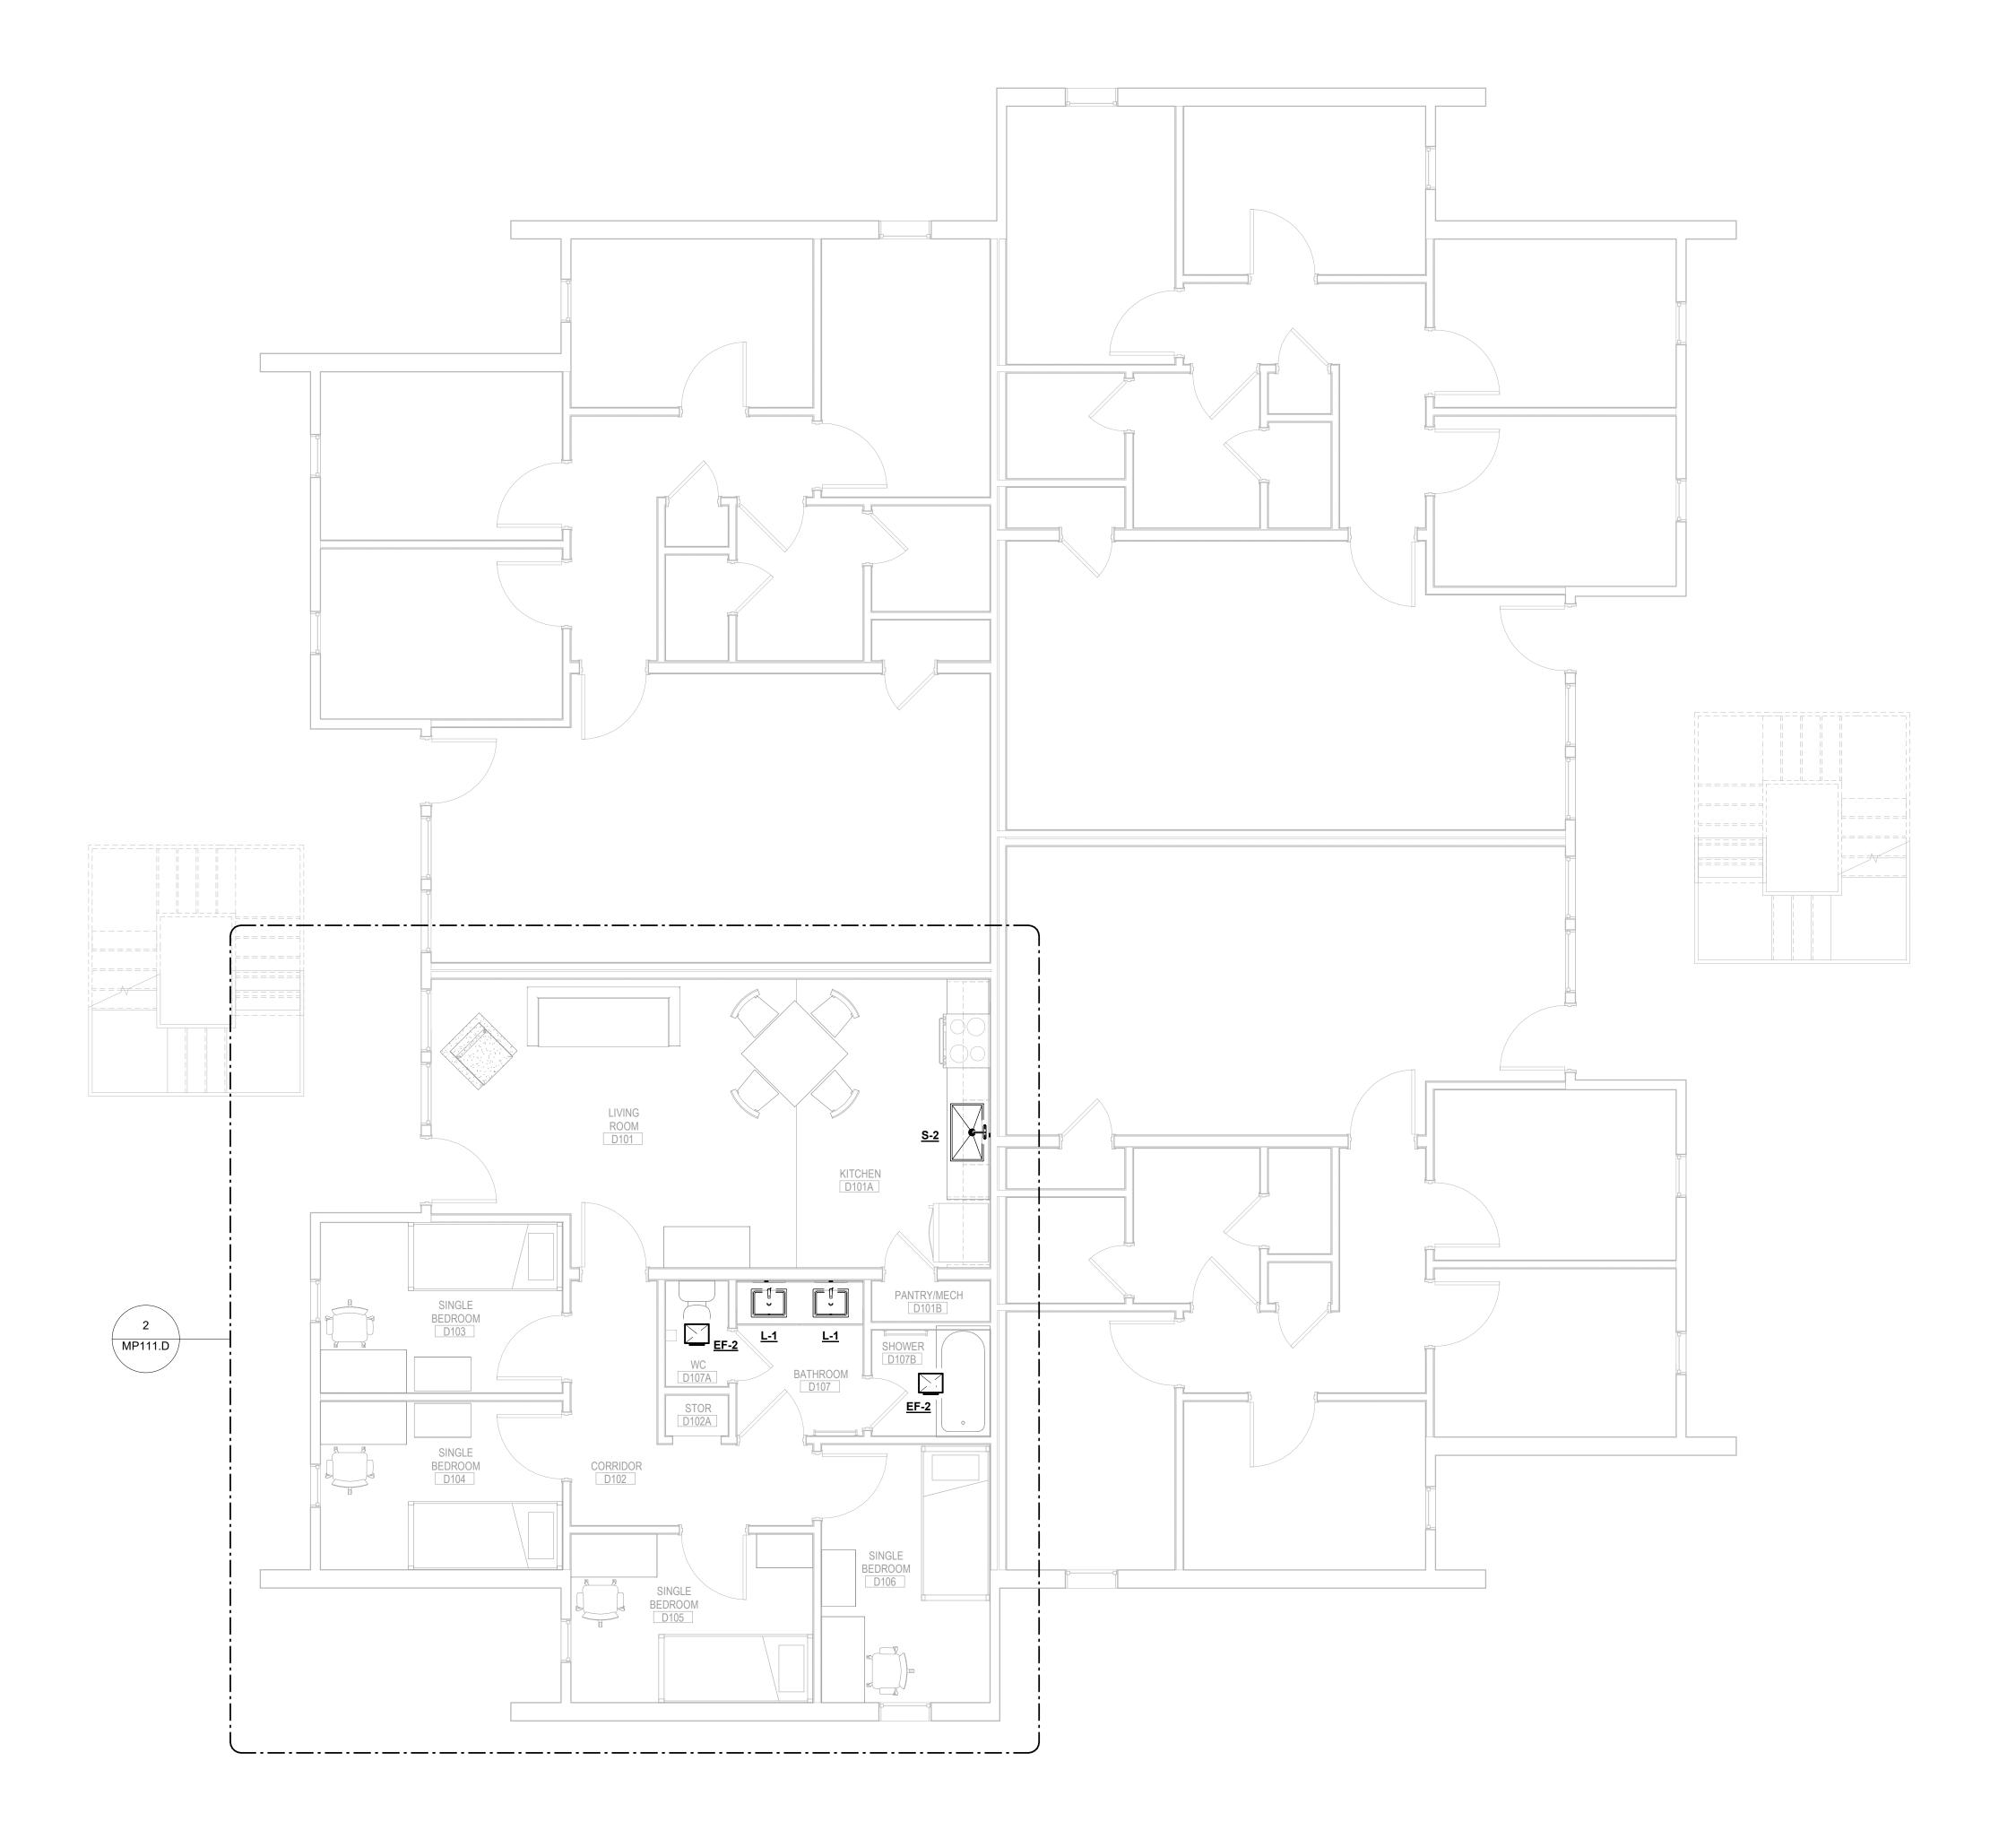


MECHANICAL & PLUMBING OVERALL FLOOR PLAN - 4BR.D - LEVEL 01


MP101.D 1/4" = 1'-0"

A102A BATHROOM MECHANICAL & PLUMBING ENLARGED FLOOR PLAN - 1BR.AB - LEVEL 01 - ADD ALT

MP111.AB 1/4" = 1'-0"

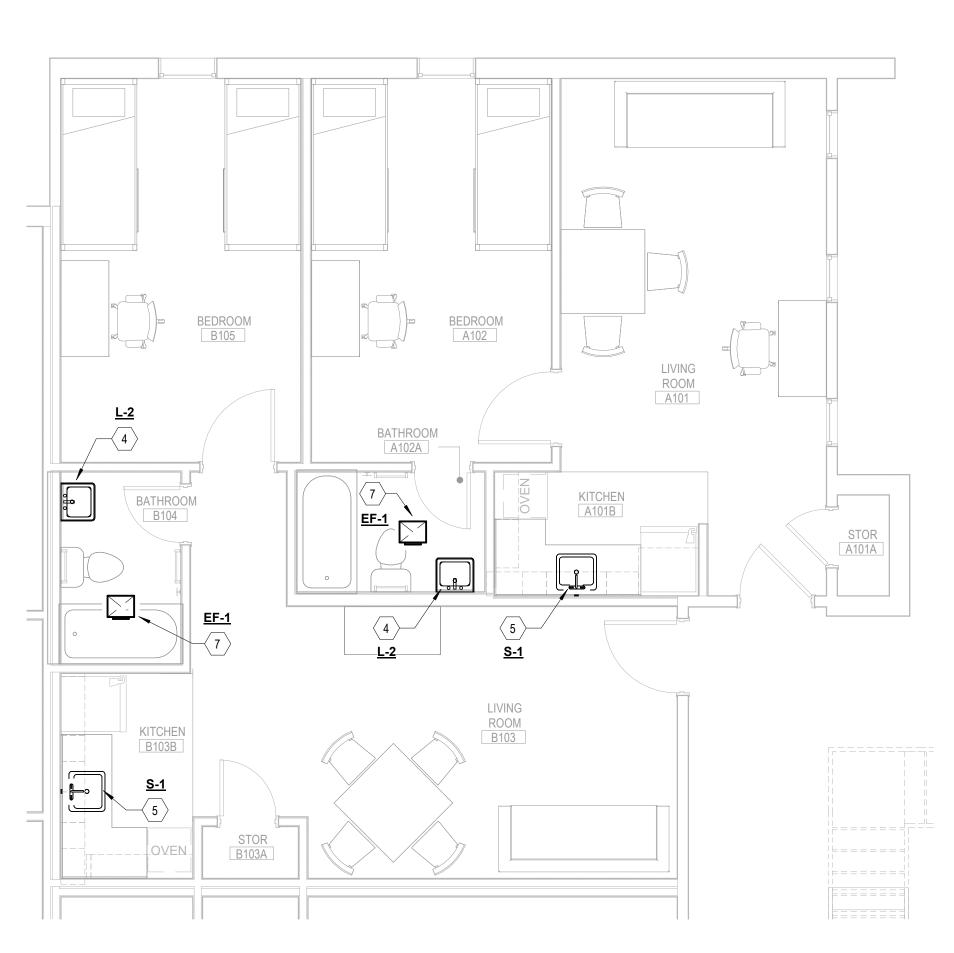

2 MECHANICAL & PLUMBING ENLARGED FLOOR PLAN - 1BR.AB - LEVEL 01 MP111.AB 1/4" = 1'-0"

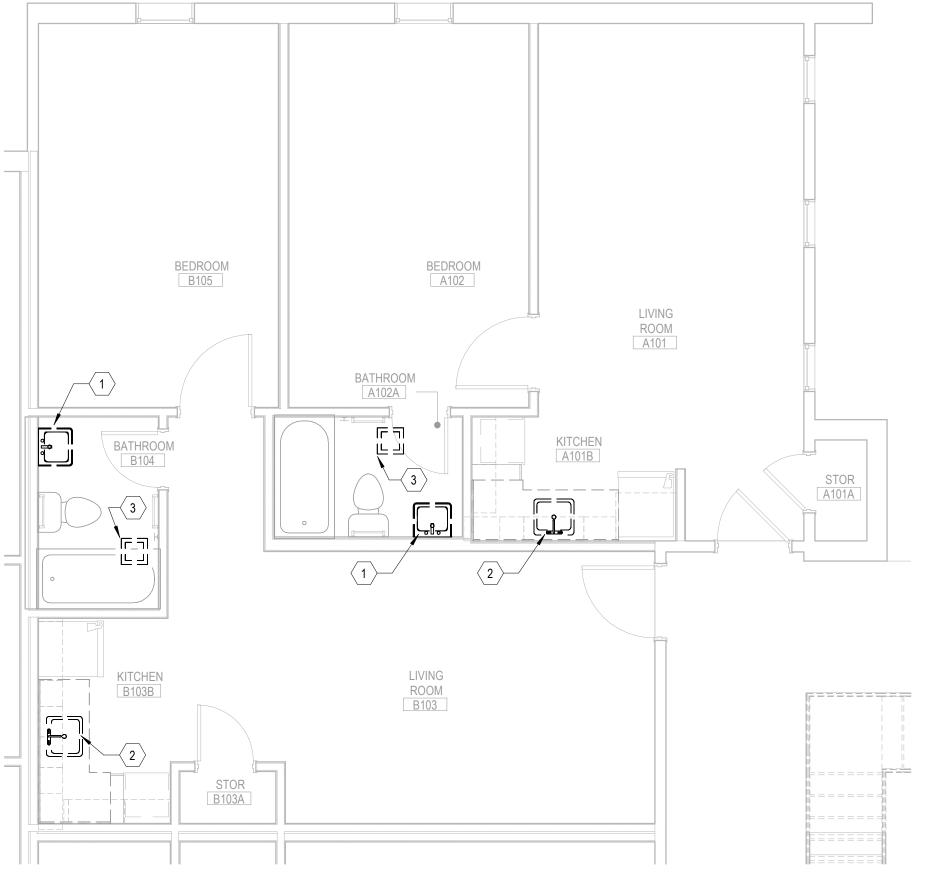

MECHANICAL & PLUMBING DEMOLITION PLAN - 1BR.AB - LEVEL 01 MP111.AB 1/4" = 1'-0"

× KEY NOTES

1. REMOVE EXISTING WALL HUNG LAVATORY, CARRIER, FAUCET, DRAIN, AND ASSOCIATED TRIM. DISCONNECT ALL CW, HW, VENT, AND SANITARY STUB-OUTS / ROUGH-INS FROM LAVATORY. EXISTING STUB-OUTS / ROUGH-INS TO REMAIN. NEW WALL HUNG LAVATORY TO BE INSTALLED WITH NEW WORK, IN SAME APPROXIMATE LOCATION, AND RECONNECTED TO EXISTING CW, HW, VENT, AND SANITARY STUB-OUTS / ROUGH-INS. REPAIR WALL AS REQUIRED. DISCONNECT AND STORE EXISTING MIXING VALVE FOR REUSE WITH NEW FIXTURE.

2. REMOVE EXISTING COUNTER MOUNTED SINK, FAUCET, DRAIN, AND ASSOCIATED TRIM. DISCONNECT ALL CW, HW, VENT, AND SANITARY STUB-OUTS / ROUGH-INS FROM SINK. EXISTING STUB-OUTS / ROUGH-INS TO REMAIN. NEW COUNTER MOUNTED SINK TO BE INSTALLED WITH NEW WORK, IN SAME APPROXIMATE LOCATION, AND RECONNECTED TO EXISTING CW, HW, VENT, AND SANITARY STUB-OUTS / ROUGH-INS. REPAIR WALL AS REQUIRED. DISCONNECT AND STORE EXISTING MIXING VALVE FOR REUSE WITH NEW FIXTURE.

3. DISCONNECT EXISTING DUCTWORK AND WIRING / ELECTRICAL CONNECTIONS, AND REMOVE EXISTING CEILING EXHAUST FAN AND ASSOCIATED TRIM. EXISTING DUCTWORK AND WIRING / ELECTRICAL CONNECTIONS TO REMAIN. NEW CEILING EXHAUST FAN-LIGHT COMBINATION TO BE INSTALLED WITH NEW WORK, IN SAME APPROXIMATE LOCATION, AND RECONNECTED TO EXISTING DUCTWORK AND WIRING / ELECTRICAL CONNECTIONS. REPAIR CEILING AS REQUIRED.

4. PROVIDE NEW WALL HUNG LAVATORY, CARRIER, FAUCET, DRAIN, AND ASSOCIATED TRIM. RECONNECT EXISTING CW, HW, VENT, AND SANITARY STUB-OUTS / ROUGH-INS FROM PREVIOUS FIXTURE, AND MATCH EXISTING PIPE SIZES. MODIFY AND EXTEND / TRIM EXISTING CW, HW, VENT, AND SANITARY STUB-OUTS / ROUGH-INS AS REQUIRED. RECONNECT AND REUSE EXISTING MIXING VALVE.

5. PROVIDE NEW UNDERMOUNT SINK, FAUCET, DRAIN, SIDE-SPRAYER, AND ASSOCIATED TRIM. RECONNECT EXISTING CW, HW, VENT, AND SANITARY STUB-OUTS / ROUGH-INS FROM PREVIOUS FIXTURE, AND MATCH EXISTING PIPE SIZES. MODIFY AND EXTEND / TRIM EXISTING CW, HW, VENT, AND SANITARY STUB-OUTS / ROUGH-INS AS REQUIRED. RECONNECT AND REUSE EXISTING MIXING VALVE.

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7. PROVIDE NEW CEILING EXHAUST FAN-LIGHT COMBINATION, ASSOCIATED TRIM, AND DUCT ADAPTER IF REQUIRED. RECONNECT EXISTING DUCTWORK AND WIRING / ELECTRICAL CONNECTIONS FROM PREVIOUS CEILING EXHAUST FAN, AND MATCH OUTLET DUCTWORK CONNECTION SIZE OF NEW EXHAUST FAN-LIGHT COMBINATION. MODIFY AND EXTEND / TRIM EXISTING DUCTWORK AND WIRING / ELECTRICAL CONNECTIONS AS REQUIRED. COORDINATE FINAL LOCATION OF EXHAUST FAN-LIGHT COMBINATION.

#### GENERAL SHEET NOTES

- A. SEE SHEET MP001 FOR LEGEND AND GENERAL NOTES.
- B. ALL SYMBOLS ON SHEET MP001 ARE NOT NECESSARILY USED ON
- C. PIPE RUNOUTS TO FIXTURES ARE AS SCHEDULED UNLESS NOTED OTHERWISE.
- D. INCLUDE ALL CUTTING/PATCHING OF EXISTING SLAB. OBTAIN WRITTEN APPROVAL FROM THE LANDLORD/OWNER PRIOR TO CUTTING/PATCHING.
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1 BR UNIT A

1 BR UNIT B

KEY PLAN



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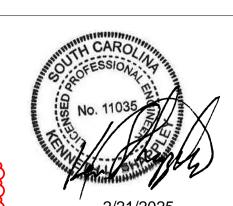
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CONSTRUCTION DOCUMENTS

1 OSE Comments

PROJECT TEAM DON BAUS

PROJECT MANAGER

SYDNEY KERSCHEN DESIGN TEAM

JASONSWISTUM


VILLAGE APARTMENTS INTERIOR RENOVATION, 4822 E. PALMETTO ST, FLORENCE, SC 29506 OSE PROJECT NUMBER -H18-N095-SG

PROJECT NO. 414.21976.00


SHEET TITLE MECHANICAL & PLUMBING ENLARGED FLOOR PLANS -1BR.AB - LEVEL 01

MP111.AB

MP111.C 1/4" = 1'-0"

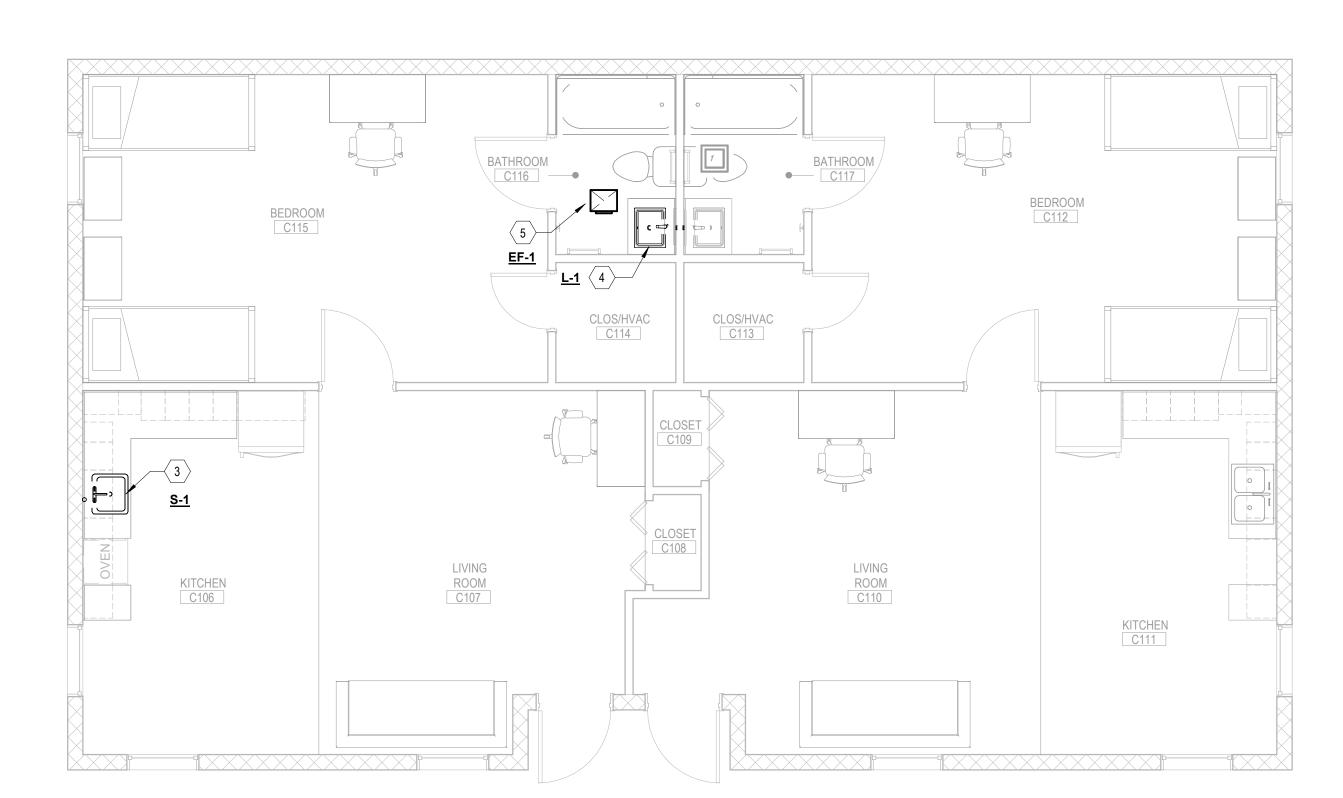

MECHANICAL & PLUMBING ENLARGED FLOOR PLAN - 1BR.C - LEVEL 01

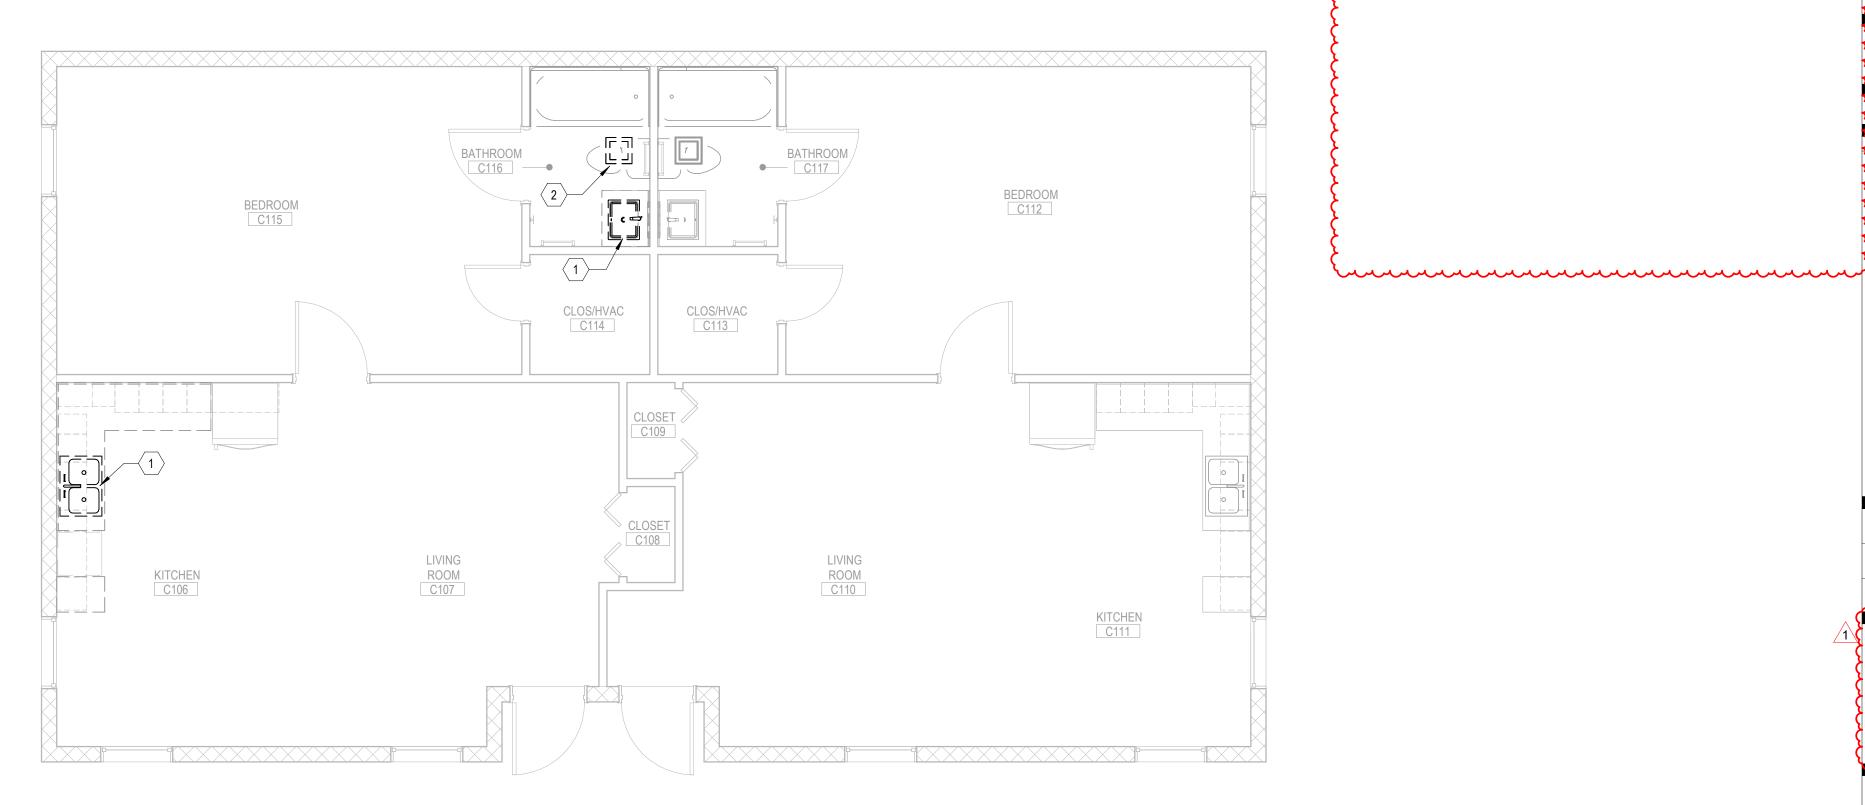

MECHANICAL & PLUMBING DEMOLITION PLAN - 1BR.C - LEVEL 01 MP111.C 1/4" = 1'-0"

× KEY NOTES

1. REMOVE EXISTING COUNTER MOUNTED SINK/LAVATORY, FAUCET, DRAIN, AND ASSOCIATED TRIM. DISCONNECT ALL CW, HW, VENT, AND SANITARY STUB-OUTS / ROUGH-INS FROM SINK, EXISTING STUB-OUTS / ROUGH-INS TO REMAIN. NEW COUNTER MOUNTED SINK TO BE INSTALLED WITH NEW WORK, IN SAME APPROXIMATE LOCATION, AND RECONNECTED TO EXISTING CW, HW, VENT, AND SANITARY STUB
Charlotte, NC 28202 OUTS / ROUGH-INS. REPAIR WALL AS REQUIRED. DISCONNECT AND STORE EXISTING MIXING VALVE FOR REUSE WITH NEW FIXTURE.

2. DISCONNECT EXISTING DUCTWORK AND WIRING / ELECTRICAL CONNECTIONS, AND REMOVE EXISTING CEILING EXHAUST FAN AND ASSOCIATED TRIM. EXISTING DUCTWORK AND WIRING / ELECTRICAL CONNECTIONS TO REMAIN. NEW CEILING EXHAUST FAN-LIGHT COMBINATION TO BE INSTALLED WITH NEW WORK, IN SAME APPROXIMATE LOCATION, AND RECONNECTED TO EXISTING DUCTWORK AND WIRING / ELECTRICAL CONNECTIONS. REPAIR CEILING AS REQUIRED.

3. PROVIDE NEW UNDERMOUNT SINK, FAUCET, DRAIN, SIDE-SPRAYER, AND ASSOCIATED TRIM. RECONNECT EXISTING CW, HW, VENT, AND SANITARY STUB-OUTS / ROUGH-INS FROM PREVIOUS FIXTURE, AND MATCH EXISTING PIPE SIZES. MODIFY AND EXTEND / TRIM EXISTING CW, HW, VENT, AND SANITARY STUB-OUTS / ROUGH-INS AS REQUIRED. RECONNECT AND REUSE EXISTING MIXING VALVE.

4. PROVIDE NEW UNDERMOUNT LAVATORY, FAUCET, DRAIN, AND ASSOCIATED TRIM. RECONNECT EXISTING CW, HW, VENT, AND SANITARY STUB-OUTS / ROUGH-INS FROM PREVIOUS FIXTURE, AND MATCH EXISTING PIPE SIZES. MODIFY AND EXTEND / TRIM EXISTING CW, HW, VENT, AND SANITARY STUB-OUTS / ROUGH-INS AS REQUIRED. RECONNECT AND REUSE EXISTING MIXING VALVE.

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#### GENERAL SHEET NOTES

OTHERWISE.

- A. SEE SHEET MP001 FOR LEGEND AND GENERAL NOTES.
- B. ALL SYMBOLS ON SHEET MP001 ARE NOT NECESSARILY USED ON
- C. PIPE RUNOUTS TO FIXTURES ARE AS SCHEDULED UNLESS NOTED
- D. INCLUDE ALL CUTTING/PATCHING OF EXISTING SLAB. OBTAIN WRITTEN APPROVAL FROM THE LANDLORD/OWNER PRIOR TO CUTTING/PATCHING.
- E. DRAWINGS WERE PREPARED BASED ON NON-DESTRUCTIVE FIELD WORK. EXISTING PIPING SHOWN ON PLANS IS SCHEMATIC AND MAY NOT NECESSARILY REPRESENT EXACT LOCATIONS. THE CONTRACTOR SHALL VISIT THE SITE PRIOR TO BIDDING TO VERIFY EXISTING UTILITIES. NO ADDITIONAL COST ARE TO BE BORNE BY THE OWNER AS A RESULT OF UTILITY CONFIGURATION DISCREPANCIES THAT WOULD BE REASONABLY DETECTED AS A RESULT OF THIS PRE
- F. TYPICAL UNIT LAYOUT SHOWN. CONTRACTOR TO FIELD VERIFY CONDITIONS IN EACH UNIT AND NOTIFY ARCHITECTURAL TEAM IF SIGNIFICANT VARIATIONS EXIST, BEFORE PROCEEDING WITH WORK. EXACT DEVICE AND FIXTURE LOCATIONS MAY VARY. COORDINATE WITH EXISTING CONDITIONS ON A UNIT BY UNIT BASIS.

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CONSTRUCTION DOCUMENTS

1 OSE Comments

PROJECT TEAM DON BAUS

PROJECT MANAGER SYDNEY KERSCHEN

VILLAGE APARTMENTS INTERIOR RENOVATION, 4822 E. PALMETTO ST, FLORENCE, SC 29506 OSE PROJECT NUMBER -H18-N095-SG

414.21976.00

PROJECT NO.

SHEET TITLE MECHANICAL & PLUMBING ENLARGED FLOOR PLANS -1BR.C - LEVEL 01

MP111.C

ROOM D101

SINGLE BEDROOM D105

MECHANICAL & PLUMBING ENLARGED FLOOR PLAN - 4BR.D - LEVEL 01

BEDROOM

SINGLE BEDROOM D104

MP111.D 1/4" = 1'-0"

D101A

SHOWER D107B

SINGLE BEDROOM

D106

1. REMOVE EXISTING COUNTER MOUNTED SINK/LAVATORY, FAUCET, DRAIN, AND ASSOCIATED TRIM. DISCONNECT ALL CW, HW, VENT, AND SANITARY STUB-OUTS / ROUGH-INS FROM SINK, EXISTING STUB-OUTS / ROUGH-INS TO REMAIN. NEW COUNTER MOUNTED SINK TO BE INSTALLED WITH NEW WORK, IN SAME APPROXIMATE LOCATION, AND RECONNECTED TO EXISTING CW, HW, VENT, AND SANITARY STUB
Charlotte, NC 28202

2. DISCONNECT EXISTING DUCTWORK AND WIRING / ELECTRICAL CONNECTIONS TO REMAIN. NEW CEILING EXHAUST FAN-LIGHT COMBINATION TO BE INSTALLED WITH NEW WORK, IN SAME APPROXIMATE LOCATION, AND RECONNECTED TO EXISTING DUCTWORK AND WIRING / ELECTRICAL CONNECTIONS. REPAIR CEILING AS REQUIRED.

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## GENERAL SHEET NOTES

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- C. PIPE RUNOUTS TO FIXTURES ARE AS SCHEDULED UNLESS NOTED
- D. INCLUDE ALL CUTTING/PATCHING OF EXISTING SLAB. OBTAIN WRITTEN APPROVAL FROM THE LANDLORD/OWNER PRIOR TO
- E. DRAWINGS WERE PREPARED BASED ON NON-DESTRUCTIVE FIELD WORK. EXISTING PIPING SHOWN ON PLANS IS SCHEMATIC AND MAY NOT NECESSARILY REPRESENT EXACT LOCATIONS. THE CONTRACTOR SHALL VISIT THE SITE PRIOR TO BIDDING TO VERIFY EXISTING UTILITIES. NO ADDITIONAL COST ARE TO BE BORNE BY THE OWNER AS A RESULT OF UTILITY CONFIGURATION DISCREPANCIES THAT WOULD BE REASONABLY DETECTED AS A RESULT OF THIS PRE
- F. TYPICAL UNIT LAYOUT SHOWN. CONTRACTOR TO FIELD VERIFY CONDITIONS IN EACH UNIT AND NOTIFY ARCHITECTURAL TEAM IF SIGNIFICANT VARIATIONS EXIST, BEFORE PROCEEDING WITH WORK. EXACT DEVICE AND FIXTURE LOCATIONS MAY VARY. COORDINATE



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 CONSTRUCTION DOCUMENTS

1 OSE Comments

PROJECT TEAM DON BAUS

PROJECT MANAGER SYDNEY KERSCHEN

VILLAGE APARTMENTS INTERIOR RENOVATION,

4822 E. PALMETTO ST, FLORENCE, SC 29506 OSE PROJECT NUMBER -H18-N095-SG

414.21976.00

SHEET TITLE MECHANICAL & PLUMBING ENLARGED FLOOR PLANS -4BR.D - LEVEL 01

MP111.D

× KEY NOTES

OUTS / ROUGH-INS. REPAIR WALL AS REQUIRED. DISCONNECT AND STORE EXISTING MIXING VALVE FOR REUSE WITH NEW FIXTURE.

CONNECTIONS, AND REMOVE EXISTING CEILING EXHAUST FAN AND ASSOCIATED TRIM. EXISTING DUCTWORK AND WIRING / ELECTRICAL

AND ASSOCIATED TRIM. RECONNECT EXISTING CW, HW, VENT, AND SANITARY STUB-OUTS / ROUGH-INS FROM PREVIOUS FIXTURE, AND MATCH EXISTING PIPE SIZES. MODIFY AND EXTEND / TRIM EXISTING

ASSOCIATED TRIM. RECONNECT EXISTING CW, HW, VENT, AND SANITARY STUB-OUTS / ROUGH-INS FROM PREVIOUS FIXTURE, AND MATCH EXISTING PIPE SIZES. MODIFY AND EXTEND / TRIM EXISTING


COMBINATION.

OTHERWISE. CUTTING/PATCHING.

KEY PLAN

4 BR UNIT

WITH EXISTING CONDITIONS ON A UNIT BY UNIT BASIS.

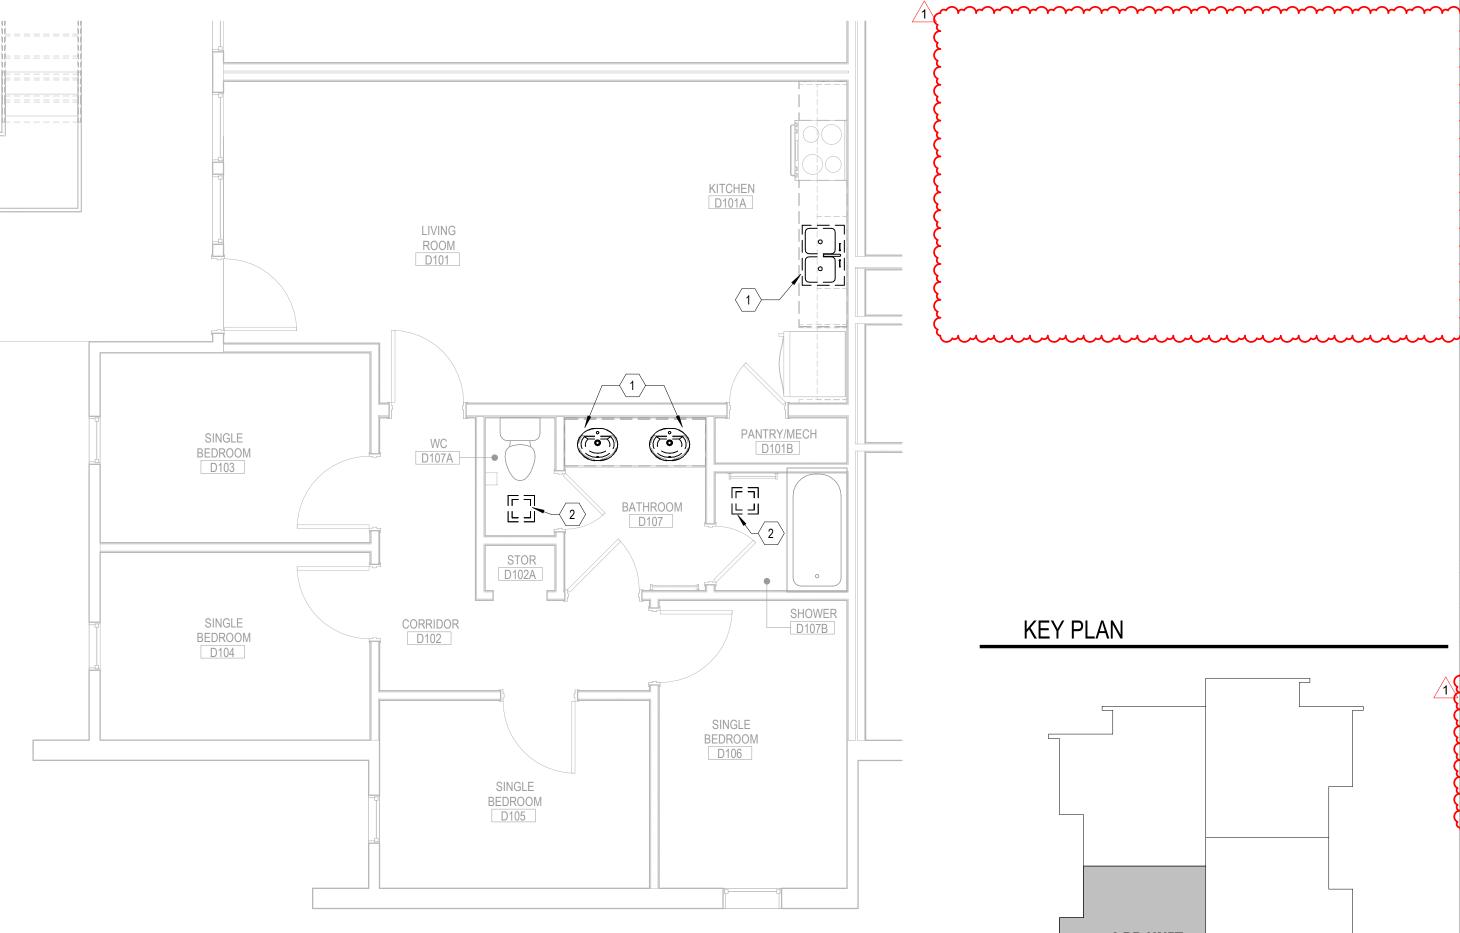

MECHANICAL & PLUMBING DEMOLITION PLAN - 4BR.D - LEVEL 01

MP111.D 1/4" = 1'-0"

ON/OFF EXHAUST FAN SCHEMATIC MP501 NOT TO SCALE

STRUCTURE ABOVE WITH METAL STRAPS & VIBRATION ISOLATION **FLEXIBLE** CONNECTION -- CEILING EXHAUST PROVIDE BDD AND WALL CAP REGISTER **MODEL RA** 

MOUNT FAN FROM

CEILING EXHAUST FAN DETAIL MP501 NOT TO SCALE

 SEE DRAWING FOR DIMENSIONS OF DUCT, DUCT DIMENSIONS ARE INSIDE CLEAR DUCT SUPPORT FROM STRUCTURE ABOVE (TYP) 1", 1.5# DENSITY ACOUSTICAL DUCT LINER (TYP) (RETURN ONLY) 30" MINIMUM — EXHAUST/RETURN GRILLE — CEILING GRID

EXHAUST/RETURN GRILLE DETAIL MP501 NOT TO SCALE

MAXIMUM PIPE/TUBING SUPPORT SPACING, FEET

 NOM. SIZE
 THRU 3/4
 1
 1 1/4
 1 1/2
 2
 2 1/2
 3
 4
 5
 6
 8
 10
 12
 14
 16
 18
 20
 22

 PIPE
 7 FT
 7
 9
 10
 11
 12
 14
 16
 17
 19
 22
 23
 25
 27
 28
 30
 32

 TUBING
 5 FT
 6
 7
 8
 8
 9
 10
 12
 13
 14
 16
 <td

— INSULATION (VAPOR BARRIER TYPE REQUIRED FOR

INSULATION SHIELD AT HANGER OR PRE-INSULATED CALCIUM SILICATE SHIELD

PROVIDE INSULATION SHIELD

— SADDLE OR PRE-INSULATED CALCIUM SILICATE SHIELD

AND INSERT FOR ALL PIPING 8"

— PROVIDE HIGH COMPRESSIVE STRENGTH INSULATION. INSERT BLOCKS UNDER INSULATION-PRE INSULATED CALCIUM SILICATE

1" MAX.

TRAPEZE HANGER FOR UP TO 1000 POUND UNIFORM LOAD

— 1-5/8" 12 GAUGE CHANNEL OR 2"x2"x1/4" ANGLE

NOTE: FOR TRAPEZE HANGER - TAKE SPACING OF SMALLEST SIZE ON TRAPEZE.

ADJUSTABLE CLEVIS
HANGER PART 1

ADJUSTABLE ROLLER HANGER TYPE 43

4 PIPE HANGAR DETAILS

MP501 NOT TO SCALE

— HANGER ROD

LOW TEMP. PIPE)

— HANGER ROD


INSULATION

MAX. -

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No. C01205



CONSTRUCTION DOCUMENTS

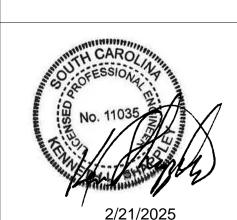02/14/2025

1 OSE Comments

PROJECT TEAM PRINCIPAL IN CHARGE

DON BAUS PROJECT MANAGER
SYDNEY KERSCHEN DESIGN TEAM


JASON SVISTUN

VILLAGE APARTMENTS INTERIOR RENOVATION, 4822 E. PALMETTO ST, FLORENCE, SC 29506 OSE PROJECT NUMBER -

H18-N095-SG 414.21976.00

SHEET TITLE MECHANICAL & PLUMBING DETAILS

MP501

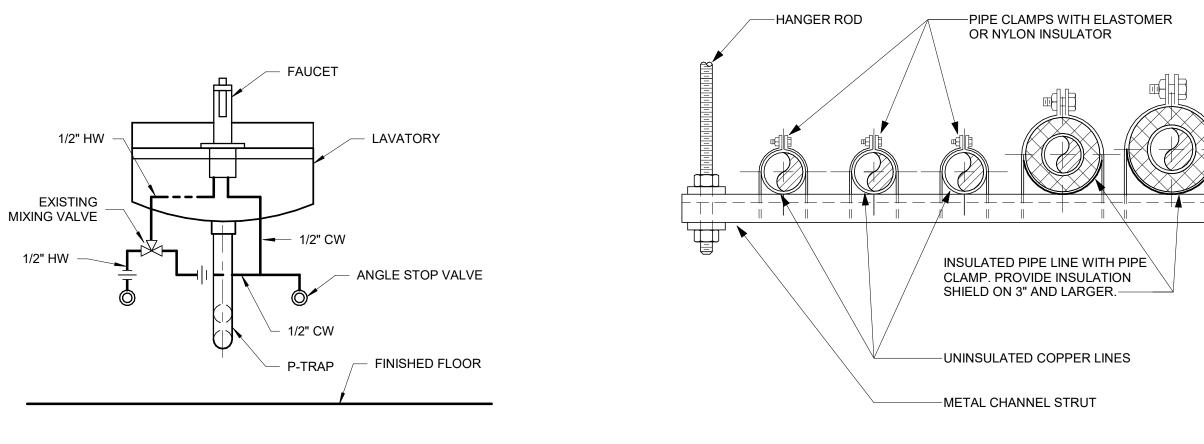


1/2" HW -


MP501 NOT TO SCALE

6 MIXING VALVE LAVATORY/SINK

5 TRAPEZE PIPE HANGER DETAIL

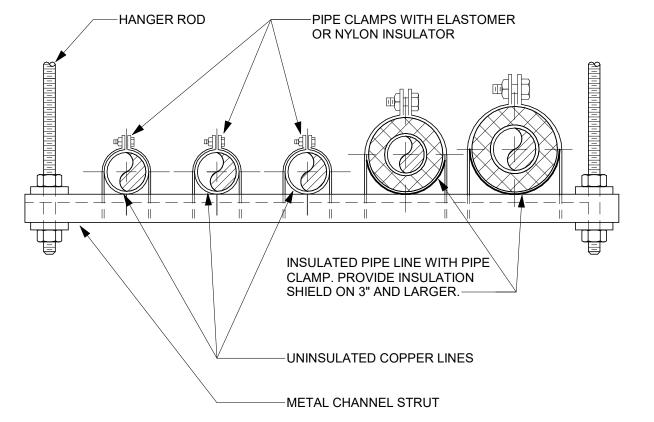

MP501 NOT TO SCALE

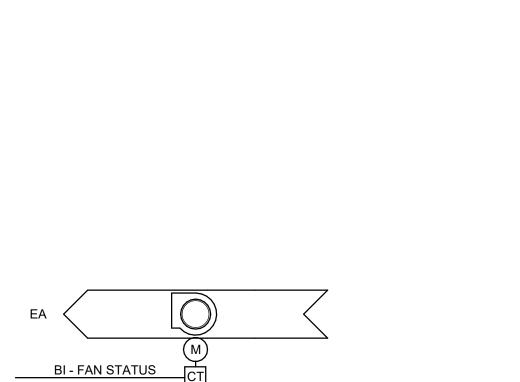

BO - FAN START/STOP

2. CONTRACTOR SHALL OBTAIN ALL PERMITS AND PAY SUCH FEES AS MAY BE NECESSARY FOR INSPECTIONS, TESTS, AND OTHER SERVICES NEEDED FOR THE COMPLETION OF WORK.

3. IT IS THE INTENT OF THESE DRAWINGS AND OTHER RELATED DOCUMENTS TO PRODUCE A COMPLETE AND FUNCTIONING ELECTRICAL SYSTEM. THE CONTRACTOR SHALL PROVIDE ALL LABOR, MATERIALS, AND OTHER SERVICES AS MAY BE NECESSARY TO ACHIEVE THIS PRODUCT. IT SHALL BE THE RESPONSIBILITY OF THE CONTRACTOR TO BRING TO THE ATTENTION OF THE ENGINEER ANY DISCREPANCIES IN THE PLANS AND SPECIFICATIONS THAT WILL AFFECT THE WORK, PRIOR TO SUBMISSION OF THE PRICE.

4. ALL MATERIAL SHALL BE NEW AND BEAR THE UL LABEL OR OTHER APPROVED THIRD PARTY TESTING LAB INDICATING THE LISTING FOR ITS INSTALLED APPLICATION.

5. CONTRACTOR SHALL UTILIZE ARCHITECTURAL REFLECTED CEILING PLANS FOR EXACT LOCATIONS OF LIGHTING FIXTURES AND ALL OTHER LIGHTING/ELECTRICAL/SPECIAL SYSTEMS CEILING DEVICES.

6. CONTRACTOR SHALL UTILIZE MECHANICAL/PLUMBING PLANS FOR EXACT LOCATIONS OF ALL MECHANICAL/PLUMBING EQUIPMENT

ELECTRICAL DRAWINGS ARE DIAGRAMMATIC. DO NOT SCALE DRAWINGS EXCEPT WHERE DIMENSIONS ARE SHOWN.

8. CONTRACTOR TO CONSULT PLANS OF ALL OTHER TRADES FOR COORDINATION AND FOR RELATED AND ADJOINING WORK.

9. CONTRACTOR TO CONSULT ARCHITECTURAL AND STRUCTURAL PLANS AND DETAILS FOR CONSTRUCTION TYPE, HEADROOM, CEILINGS, FINISHES, ETC. CONTRACTOR TO COORDINATE ALL CONDUITS AND ELECTRICAL DEVICES/BOXES WITH ARCHITECT AS RELATED TO WALL CONSTRUCTION TYPE PRIOR TO INSTALLATION.

10. ALL CONDUCTORS IN ELECTRICAL SYSTEM SHALL BE NO. 12 AWG COPPER MINIMUM UNLESS SPECIFICALLY LABELED OTHERWISE OR AS REQUIRED BY SPECIFICATIONS OR CODE. THE CORRECT NUMBER OF WIRES MAY NOT BE INDICATED FOR ALL CIRCUITS, ONLY THOSE WHERE CLARIFICATION IS NECESSARY. THE CONTRACTOR SHALL PROVIDE ALL WIRES NECESSARY FOR THE PROPER FUNCTION OF THE SYSTEM.

11. ALL EMPTY CONDUIT RUNS IN EXCESS OF 10 FEET SHALL BE PROVIDED WITH A PULL STRING OR FISH TAPE.

12. RACEWAYS SHALL BE CONCEALED IN FINISHED SPACES AND AS PER SPECS. WHERE APPLICABLE, EXPOSED CONDUITS MOUNTED TO STRUCTURE SHALL BE RUN AS INCONSPICUOUSLY AS POSSIBLE, AND SHALL BE PAINTED TO MATCH SURFACE TO WHICH THEY ARE MOUNTED. CONDUITS SHALL RUN PARALLEL TO BUILDING LINES. ALL EXPOSED JUNCTION BOXES SHALL BE WEATHERPROOF, WITH NO KNOCKOUT.

13. ALL DEVICES INDICATED AS REQUIRING AN ISOLATED GROUND CONNECTION SHALL BE SERVED VIA A BRANCH CIRCUIT CONTAINING AN INSULATED ISOLATED GROUND CONDUCTOR IN ADDITION TO AN INSULATED EQUIPMENT GROUNDING CONDUCTOR. THE ISOLATED GROUND CONDUCTOR SHALL BE CONNECTED TO THE ISOLATED GROUND BUS IN THE PANELBOARD SERVING THE DEVICE.

14. PROVIDE "LOCKING" TYPE DEVICES ON ALL CIRCUIT BREAKERS THAT WILL SERVE EMERGENCY LIGHTING, EXIT SIGNS, FIRE ALARM SYSTEMS EMERGENCY COMMUNICATIONS SYSTEM, AND SECURITY SYSTEMS.

15. PROVIDE COMPLIANCE WITH ANSI A117.1 FOR ADA REQUIREMENTS.

16. CONTRACTOR SHALL INCREASE WIRE SIZE AS REQUIRED TO MAINTAIN A 5-PERCENT WORST CASE VOLTAGE DROP, FROM SERVICE ENTRANCE TO FURTHEST DEVICE.

17. EACH INDIVIDUAL BRANCH CIRCUIT SHALL HAVE A DEDICATED NEUTRAL UNLESS INDICATED OTHERWISE. WHEN MULTI-WIRE BRANCH CIRCUITS ARE SPECIFIED TO BE INSTALLED, PROVIDE MULTI-POLE CIRCUIT BREAKERS AS REQUIRED BY NEC 210.4. PROVIDE A #10 NEUTRAL CONDUCTOR FOR ALL MULTI-WIRE RECEPTACLE BRANCH CIRCUITS.

18. POWER RATINGS INDICATED ON DRAWINGS MAY DIFFER FROM THE ACTUAL EQUIPMENT FURNISHED. IF FURNISHED EQUIPMENT DIFFERS FROM RATINGS ON THE DRAWINGS, CONTRACTOR SHALL NOTIFY ENGINEER FOR APPROPRIATE ACTION TO BE TAKEN.

19. HORSEPOWER RATINGS INDICATED ON DRAWINGS MAY DIFFER FROM THE ACTUAL EQUIPMENT FURNISHED. IF FURNISHED EQUIPMENT DIFFERS FROM RATINGS ON THE DRAWINGS, THE CONTRACTOR SHALL NOTIFY ENGINEER FOR APPROPRIATE ACTION TO BE TAKEN.

20. PROVIDE AND SIZE ALL MOTOR OVERLOAD DEVICES IN STARTERS. BASED ON ACTUAL NAMEPLATE RATINGS ON THE MOTORS BEING INSTALLED.

21. CONTRACTOR SHALL NOTE UL LABELS ON PACKAGE-TYPE MECHANICAL EQUIPMENT. IF UL LABEL ON MECHANICAL EQUIPMENT CALLS FOR THE OVERCURRENT PROTECTIVE DEVICE TO BE FUSES, THE CONTRACTOR SHALL PROVIDE A FUSED DISCONNECT SWITCH WITH PROPERLY SIZED

FUSES AT THE SWITCH LOCATION INDICATED ON THE DRAWINGS. 22. CONTRACTOR SHALL VERIFY WIRE SIZES, FUSE RATINGS, AND CIRCUIT BREAKER RATINGS FOR ALL HVAC EQUIPMENT, AND SHALL BRING TO THE ATTENTION OF THE ENGINEER ANY DISCREPANCIES AFFECTING THE WORK, PRIOR TO PROCEEDING.

23. ALL ELECTRIC DRINKING FOUNTAINS SHALL BE PROTECTED WITH GROUND-FAULT CIRCUIT-INTERRUPTER PROTECTION. PROVIDE GFCI TYPE CIRCUIT BREAKERS FEEDING ELECTRIC DRINKING FOUNTAINS (EWC).

D 24. ALL EXTERIOR RECEPTACLES SHALL BE LISTED WEATHER-RESISTANT TYPE, BE GFI PROTECTED AND HAVE AN ENCLOSURE/COVERPLATE THAT IS WEATHERPROOF (WITH THE ATTACHMENT PLUG CAP INSERTED OR REMOVED). OUTLET BOX HOOD, IF INSTALLED SHALL BE EXTRA DUTY RATED. REFER TO SPECIFICATIONS.

25. ALL DEVICES (INCLUDING LIGHT SWITCH BOXES, ELECTRICAL OUTLET BOXES, AND FIRE ALARM PULL STATIONS) SHALL NOT BE RECESSED INTO THE OUTER MEMBRANE OF EXIT STAIR ENCLOSURES. LOCATE THESE DEVICES AS REQUIRED. THERE SHALL BE NO PENETRATIONS INTO AND OPENINGS THROUGH AN EXIT ENCLOSURE ASSEMBLY PER NFPA 101: 7.1.3.2.1(9).

26. ALL SINGLE-PHASE RECEPTACLES RATED 150 VOLTS TO GROUND OR LESS, 50 AMPERES OR LESS AND THREE-PHASE RECEPTACLES RATED 150 VOLTS TO GROUND OR LESS, 100 AMPERES OR LESS INSTALLED IN THE FOLLOWING LOCATIONS SHALL HAVE GROUND-FAULT CIRCUIT-INTERRUPTER PROTECTION FOR PERSONNEL: BATHROOMS, KITCHENS, ROOFTOPS, SINKS (INSTALLED WITHIN 6FT FROM THE TOP INSIDE EDGE OF BOWL OF THE SINK), INDOOR WET LOCATIONS, LAUNDRY ROOM AREAS, CRAWL SPACES, WITHIN 6' OF EDGE OF BATHTUB/SHOWER STALLS, AND WITHIN AREAS WHERE EQUIPMENT REQUIRES SERVICING (ELECTRICAL ROOMS, MECHANICAL ROOMS, ETC.).

27. GENERAL GUIDELINES FOR 20-AMP. SINGLE PHASE 120 AND 277 VOLT BRANCH CIRCUITS USE FOLLOWING AS A MIMUMUM FOR CONDUCTORS SIZES: (1) 120 VOLT - #12 AWG UP TO A DISTANCE OF 75 FEET, #10 FOR DISTANCES OVER 75 FEET AND LESS THAN 150'. #8 FOR DISTANCES GREATER. (2) 277 VOLT - #12 AWG UP TO A DISTANCE OF 150 FEET, #10 FOR DISTANCES OVER 150 FEET AND LESS THAN 250'. #8 FOR DISTANCES GREATER. THIS DOES NOT PRECLUDE ADJUSTMENTS FOR CIRCUIT CONDITIONS WHICH MAY REQUIRE LARGER CONDUCTORS OR ALLOW MINUMUM SIZE CONDUCTORS DUE TO ACTUAL LOAD CONDITIONS THAT MEET THE REQUIREMENTS OF NOTE 16 ABOVE.

## GENERAL NOTES (RENOVATION)

1. CONTRACTOR SHALL VISIT THE SITE AND EXAMINE CONDITIONS OF THE PREMISES AND THE CHARACTER AND EXTENT OF WORK REQUIRED, PRIOR TO SUBMITTING PRICING. ANY DIFFICULTIES IN COMPLYING WITH THE DRAWINGS AND SPECIFICATIONS SHALL BE BROUGHT TO THE ATTENTION OF THE ENGINEER, BEFORE BEGINNING WORK.

2. ALL WORK SHALL BE DONE AT SUCH TIMES AND IN SUCH A MANNER AS WILL LEAST INTERFERE WITH THE MAINTENANCE AND OPERATION OF ALL RELATED OR AFFECTED SYSTEMS. ALL POWER OUTAGES SHALL BE COORDINATED WITH OWNER.

EXISTING BOXES, CONDUIT, AND WIRING SHALL BE REUSED IF IN GOOD CONDITION AND MEET THE REQUIREMENTS OF THE NEW WORK DEFINED IN CONTRACT DOCUMENTS, SUPPLEMENT WERE NEEDED. DO NOT REUSED IF EXISTING CIRCUITY IS A MULTIWIRE BRANCH CIRCUIT OR DOES NOT INCLUDE AN EQUIPMENT GROUND CONDUCTOR.

4. WHERE EXISTING CIRCUITS ARE EXTENDED TO SERVE NEW OR RELOCATED DEVICES OR FIXTURES, PROVIDE TYPE AND SIZE OF

5. EXISTING CIRCUITING SHALL BE FIELD VERIFIED AND ADJUSTMENTS SHALL BE MADE, IF NECESSARY, TO THE CIRCUITING SHOWN ON THE PLANS AS REQUIRED BY FIELD CONDITIONS.

WHERE ELECTRICAL WORK PENETRATES EXISTING FIRE-RATED BARRIERS (WALLS, FLOORS, AND CEILINGS), SEAL OPENING AROUND ELECTRICAL WORK WITH U.L. LISTED FIRE STOPPING MATERIAL TO MAINTAIN THE FIRE RATING OF THE BARRIER.

. PROVIDE NEW TYPE WRITTEN FINALIZED PANEL CIRCUIT DIRECTORIES FOR ALL NEW PANELS AND ALL EXISTING PANELS USED FOR

# GENERAL NOTES (DEMOLITION)

THE PROJECT AT THE COMPLETION OF THE PROJECT.

 REMOVE ALL EXISTING FIXTURES, WIRING DEVICES, ELECTRICAL EQUIPMENT AND BRANCH CIRCUIT WIRING, AS REQUIRED BY THE ARCHITECTURAL DEMOLITION WORK IN THE AREA TO BE RENOVATED. REMOVE WIRING BACK TO THE NEAREST POINT OF USAGE (SOURCE OF VOLTAGE). FOR ITEMS TO BE REMOVED, REMOVE THE ENTIRE ELECTRICAL INSTALLATION, INCLUDING ALL ASSOCIATED CONDUIT, JUNCTION BOXES, WIRING AND FITTINGS, INCLUDING CABLING AND SUPPORTS, SURFACE RACEWAY, ETC. REUSE EXISTING BOXES AND CONDUIT WHERE PRACTICAL. ALL CONDUIT NOT TO BE REUSED SHALL BE REMOVED.

2. WHERE EXISTING FIXTURES, WIRING DEVICES, AND ELECTRICAL EQUIPMENT ARE REMOVED, RECONNECT CIRCUITING AS REQUIRED TO MAINTAIN CONTINUITY TO OUTLETS REMAINING ON THE CIRCUIT WITHIN OCCUPIED SPACES.

. WHERE REQUIRED BY NEW CONSTRUCTION, PROVIDE EXTENSION RINGS, COVERPLATES, OR ACCESS PLATES AS REQUIRED TO MAINTAIN ACCESS TO EXISTING WIRING.

4. FIELD VERIFY LOCATIONS OF EXISTING OUTLETS. WHERE NEW CONSTRUCTION CONFLICTS WITH EXISTING OUTLETS, REMOVE WIRING DEVICES OR RELOCATE FIXTURES AS REQUIRED.

5. WHERE EXISTING WIRING DEVICES ARE REMOVED AND JUNCTION BOXES ARE NOT REUSED, PATCH AND REPAIR OPENINGS. DO NOT

PROVIDE BLANK COVERPLATES.. 6. WHERE EXISTING CIRCUITS ARE EXTENDED TO SERVE NEW OR RELOCATED DEVICES OR FIXTURES, PROVIDE TYPE AND SIZE OF

7. PROVIDE CUTTING AND PATCHING AS REQUIRED VERIFY EXTENT OF NEW AND EXISTING PARTITIONS WITH ARCHITECTURAL DRAWINGS.

8. EXISTING CIRCUITING SHALL BE FIELD VERIFIED AND ADJUSTMENTS SHALL BE MADE IF NECESSARY TO THE CIRCUITING SHOWN ON THE

PLANS, AS REQUIRED BY FIELD CONDITIONS.

9. REMOVE AND CAP ALL EXISTING FLOOR OUTLETS IN SUCH MANNER AS TO RETAIN THE FIRE INTEGRITY OF THE FLOOR. 10. PROVIDE EPA COMPLIANT DISPOSAL FOR ALL HAZARDOUS WASTE INCLUDING FLUORESCENT OR HID LAMPS, AND PCB BALLAST

AMPERES ALTERNATING CURRENT OR ABOVE COUNTER ARCHITECT/ENGINEER MCC AMPERE FRAME AFF MDP ABOVE FINISHED FLOOR ABOVE FINISHED GRADE MDS **AUTHORITY HAVING JURISDICTION** 

ABBREVIATIONS NOTE: ALL ABBREVIATIONS MAY NOT BE USED

AIR HANDLING UNIT ANSI AMERICAN NATIONAL STANDARDS INSTITUTES, INC. AMPERE TRIP AMERICAN SOCIETY FOR TESTING AND MATERIALS AUTOMATIC TRANSFER SWITCH AMERICAN WIRE GAUGE **BUILDING AUTOMATION SYSTEM** BARE COPPER BOLTED PRESSURE SWITCH

CONDUIT CIRCUIT BREAKER CBM COMMUNITY ANTENNA TELEVISION

CERTIFIED BALLAST MANUFACTURERS CLOSED CIRCUIT TELEVISION CANDELA RATING CFL CKT COMPACT FLUORESCENT CIRCUIT CLG CEILING

**CURRENT TRANSFORMER** COPPER DB DIRECT BURIAL dBA DECIBEL LEVEL DIRECT CURRENT GARBAGE DISPOSAL DOWN DWG DRAWING E.C. ELECTRICAL CONTRACTOR EMPTY CONDUIT

EXHAUST FAN **EQUIPMENT GROUND** ELBU EMERGENCY LIGHTING BATTERY UNIT EM **EMERGENCY** EQUIPMENT MANUFACTURER REQUIREMENT ELECTRIC METALLIC TUBING **EXISTING TO REMAIN** EUH ELECTRIC UNIT HEATER

EWC ELECTRIC WATER COOLER **EXISTING** FIRE ALARM FIRE ALARM ANNUNCIATOR PANEL FACP FIRE ALARM CONTROL PANEL FCU FAN COIL UNIT FDAS FIRE DETECTION ALARM SYSTEM

FLUOR FLUORESCENT FPVAV FAN POWERED VARIABLE AIR VOLUME BOX FUSE PER NAMEPLATE **GENERAL CONTRACTOR** GF,GFI GROUND FAULT CIRCUIT INTERRUPTER GROUND FAULT RELAY GFR G, GND GROUND HANDHOLE

HAND OFF AUTOMATIC HOA HORSEPOWER HFRT7 ISOLATED GROUND INTERMEDIATE METAL CONDUIT JUNCTION BOX THOUSAND CIRCULAR MILS KW KILOWATT KILO VOLT KILO VOLT-AMPERE

LIGHTING CONTROL PANEL

LOW VOLTAGE MASTER ANTENNA TELEVISION MECHANICAL CONTRACTOR MCB MAIN CIRCUIT BREAKER

MOTOR CONTROL CENTER MAIN DISTRIBUTION PANEL MAIN DISTRIBUTION SWITCHBOARD MLO MAIN LUGS ONLY MH MANHOLE MOTOR STARTER PANEL MSP MANUAL TRANSFER SWITCH MOUNTING HEIGHT

ΜT MTS MV MEDIUM VOLTAGE MW MICROWAVE NORMALLY CLOSED NATIONAL ELECTRICAL CODE NEMA NATIONAL ELECTRICAL MANUFACTURERS **ASSOCIATION** NOT IN CONTRACT

NON FUSED NFPA NATIONAL FIRE PROTECTION ASSOCIATION NIGHT LIGHT NORMALLY OPEN NTS NOT TO SCALE PA PUBLIC ADDRESS PB PULLBOX

POLE PNL PANELBOARD POTENTIAL TRANSFORMER **PWR** POWER QUARTS RESTRIKE LAMP RACEWAY REC RECEPTACLE

RECEPT REF REFRIGERATOR RELOCATE EXISTING RMC RIGID METAL CONDUIT RAPID START REMOVE EXISTING SURGE ARRESTOR SOLID NEUTRAL SURGE PROTECTION DEVICE SS SAFETY SWITCH SW SWITCH

**SWITCHBOARD** 

UNIT HEATER

SWBD

TTC

TEL

SWGR SWITCHGEAR TELEPHONE TERMINAL BOARD TELEPHONE TERMINAL CABINET **TELEPHONE** TELEVISION TRANSIENT VOLTAGE SURGE SUPPRESSOR TYPICAL UNDER COUNTER

UNDERWRITERS' LABORATORIES, INC. UNLESS OTHERWISE NOTED UON UPS UNINTERRUPTIBLE POWER SUPPLY VOLTS VAPOR PROOF VAV VARIABLE AIR VOLUME BOX VARIABLE FREQUENCY DRIVE VFD WIRE, WATTS WIRELESS ACCESS POINT

WAP WH WATER HEATER WP WEATHERPROOF XFMR TRANSFORMER

# MOUNTING HEIGHTS

COMMUNICATIONS OUTLETS:

TELE/DATA OUTLETS

CABLE TV OUTLETS

ABOVE COUNTER TOPS

(DISTANCE FROM FINISHED FLOOR TO CENTER OF DEVICE, UNLESS OTHERWISE NOTED)

RECEPTACLES: GENERAL-18" UNLESS OTHERWISE NOTED ABOVE 36" COUNTER TOPS 44" UNLESS OTHERWISE NOTED ABOVE OR ADJACENT TO LAVATORIES 44" UNLESS OTHERWISE NOTED BEHIND REFRIGERATORS 52" UNLESS OTHERWISE NOTED BEHIND WASHERS/DRYERS 44" UNLESS OTHERWISE NOTED LIGHT SWITCHES/OCCUPANCY WALL SWITCHES — 46"

NOTE: FOR ALL DEVICES LOCATED IN CMU WALL, INSTALL BOXES AS FOLLOWS: THE TOP OF THE BOX SHALL MATCH THE TOP OF THE BLOCK COURSING. MOUNT BOXES AT 48" TO TOP FOR SWITCHES AND 16" TO BOTTOM OF BOXES FOR OUTLETS. WHERE OUTLETS ARE SHOWN TO BE

MOUNTED HIGH, ADJUST HEIGHT AS REQUIRED TO TOP OF BLOCK COURSING.

SAME AS ADJACENT RECEPTACLE

SAME AS ADJACENT RECEPTACLE

44" UNLESS OTHERWISE NOTED

ELECTRICAL SYMBOL SCHEDULE NOTE: ALL SYMBOLS MAY NOT BE USED.

BRANCH CIRCUIT CONDUIT CONCEALED IN CEILING OR WALL (OR EXPOSED, WHERE CONCEALMENT IS NOT POSSIBLE) BRANCH CIRCUIT CONDUIT CONCEALED IN FLOOR OR UNDERGROUND HOMERUN TO PANELBOARD - NUMBER OF ARROWS INDICATES NUMBER OF CIRCUITS \_\_\_ CONDUIT TURNED UP CONDUIT TURNED DOWN JUNCTION BOX, CEILING-MOUNTED AND WALL-MOUNTED RESPECTIVELY РВ PULLBOX 208Y/120V PANELBOARD 480Y/277V PANELBOARD SERVICE OR EQUIPMENT GROUND

POWER:

DUPLEX RECEPTACLE, 20 AMP, 120V

DUPLEX RECEPTACLE MOUNTED HIGH, ABOVE COUNTER / BACKSPLASH OR AS INDICATED \*\* TYPICAL FOR ALL RECEPTACLES:

GFI = GROUND FAULT INTERRUPTER TYPE


CEILING MOUNTED LIGHT/ EXHAUST FAN COMBO. SEE MECHANICAL PLANS FOR MORE INFORMATION

<u>LIGHTING:</u>


WALL MOUNTED LIGHT FIXTURE CEILING MOUNTED LIGHT FIXTURE

TOGGLE SWITCH

TYPICAL CIRCUITING: CIRCUIT DESIGNATION

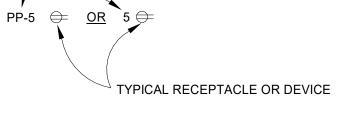

ONE SWITCH IN ROOM/AREA)

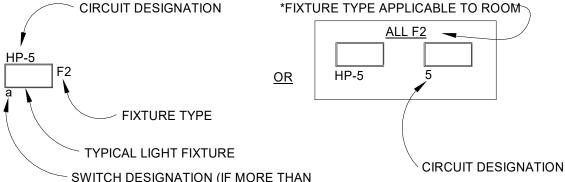


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1 OSE Comments

PROJECT TEAM D BAUS


S KERSCHEN SB. Matthew Schronce P.E.

Village Apartments Interior Renovation, FMU 


OSE PROJECT NUMBER -H18-N095-SG

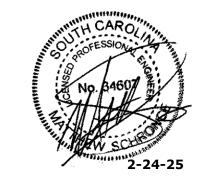PROJECT NO. 4142197600

**ELECTRICAL COVERSHEET** 

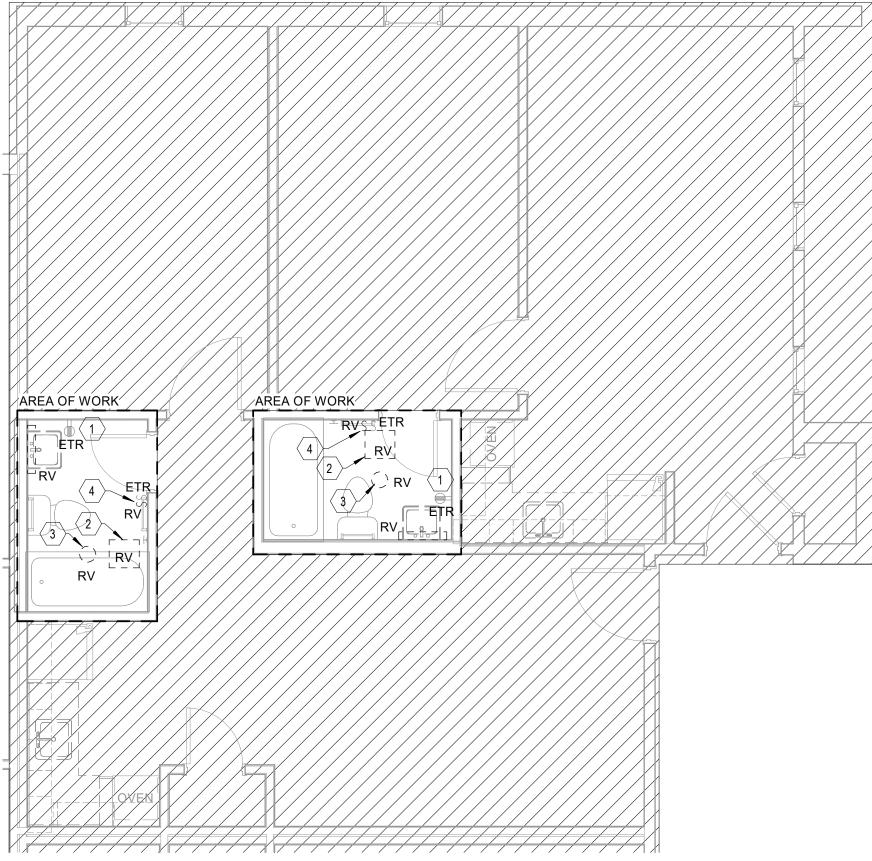



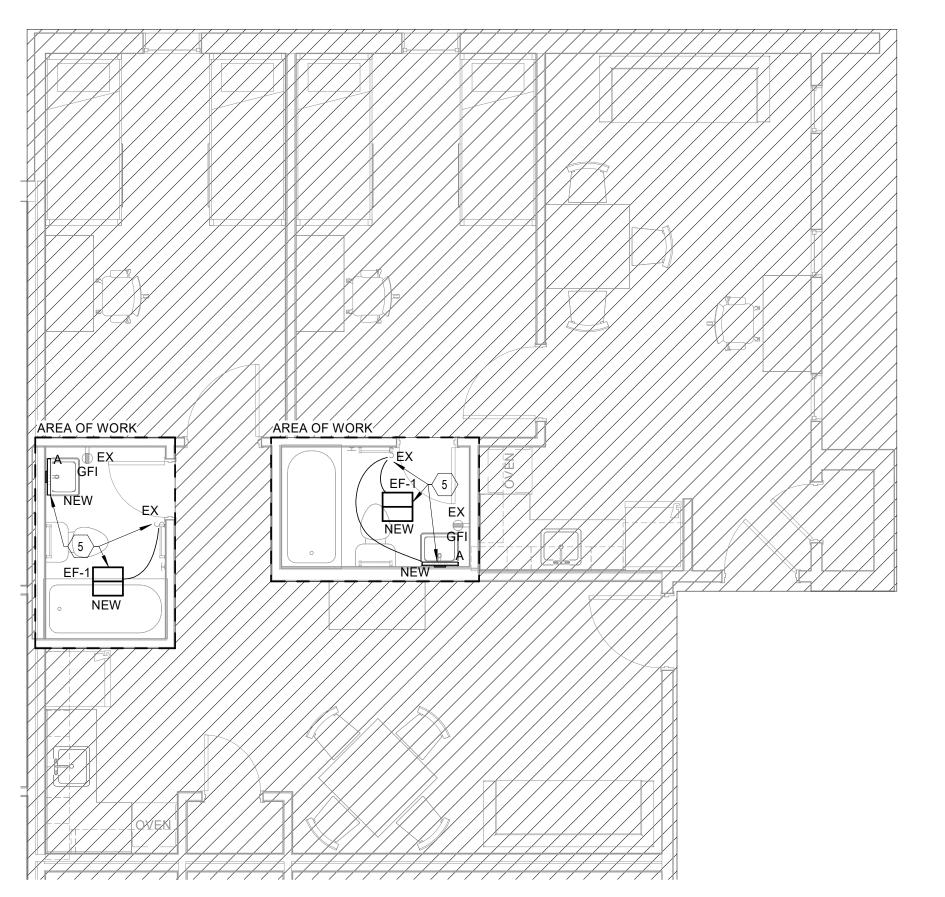

2 NEW ELECTRICAL PLAN - 1BR.AB

		LIGHTING FIXT	URE SCHEDUI	E A/B	
TYPE	DESCRIPTION	MANUFACTURER	SERIES	Apparent Load	COMMENTS
A	18" LED WALL MOUNTED LINEAR SCONCE	WAC Lighting - Brink Bathroom	WS-77618-2700K-AL-16W	16 kVA	MOUNT CENTERED ABOVE MIRROR AND CEILING.
		Sconce			

#### × KEY NOTES

- 1. CONTRACTOR SHALL FIELD VERIFY THE EXISTING RECEPTACLE TO BE GFI IN EACH BATHROOM. IF EXISTING RECEPTACLE IS NOT GFI, CONTRACTOR SHALL REPLACE RECEPTACLE WITH A NEW GFI RECEPTACLE, AND CONNECT TO EXISTING CIRCUIT. CONFIRM FINAL COLOR WITH ARCHITECT. NO LOAD CHANGE.
- . CONTRACTOR SHALL DEMOLISH EXISTING CEILING LIGHTING FIXTURE AND PROVIDE A BLANK COVER PLATE. EXACT LOCATION OF LIGHT FIXTURE SHALL BE FIELD VERIFIED. LOAD OF REMOVED LIGHTING: 200W PER BATHROOM LOAD OF NEW CEILING & SCONCE FIXTURE: 26W PER BATHROOM
  - 174W PER BATHROOM TOTAL LOAD REDUCED: . CONTRACTOR SHALL DEMOLISH EXISTING EXHAUST FAN. THE CIRCUIT FOR THE EXISTING EXHAUST SHALL REMAIN FOR CONNECTION TO NEW FAN.
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  - 5. CONTRACTOR SHALL CONNECT NEW LIGHT/EXHAUST FAN COMBO DEVICE TO EXISTING CIRCUIT THAT SERVED THE DEMOLISHED FAN. CONTROL THE NEW LIGHT/FAN COMBO DEVICE AND NEW WALL SCONCE LOCATED OVER THE MIRROR TO THE EXISTING SINGLE POLE TOGGLE SWITCH. 50W PER BATHROOM 11W PER BATHROOM LOAD OF REMOVED FAN: LOAD OF NEW FAN EF-1:

39W PER BATHROOM TOTAL LOAD REDUCED:



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GENERAL SHEET NOTES

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- B. WHERE EXISTING CIRCUITRY IS REUSED, CONTRACTOR SHALL @ 277V).
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- I. ALL NEW AND EXISTING DEVICES IN BATHROOMS SHALL HAVE EGG SHELL COLORED COVER PLATES.

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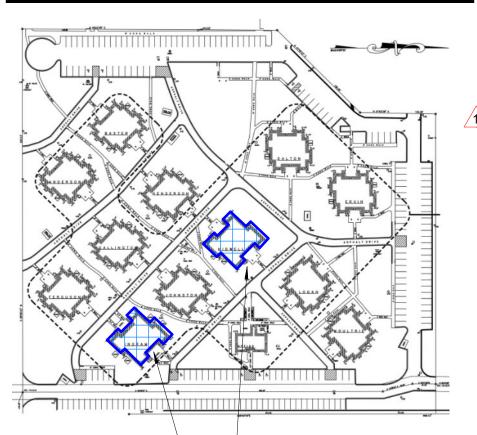


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02.14.2025

1 OSE Comments 02.24.2025

#### **KEY PLAN**



PROJECT TEAM PRINCIPAL IN CHARGE D BAUS

PROJECT MANAGER S KERSCHEN

DESIGN TEAM SCHRONCE P.E. Village Apartments Interior Renovation, FMU


OSE PROJECT NUMBER -H18-N095-SG

ELECTRICAL PLANS - 1BR.

E111.AB

1 DEMOLITION ELECTRICAL PLAN - 1BR.C

E111.C 1/4" = 1'-0"

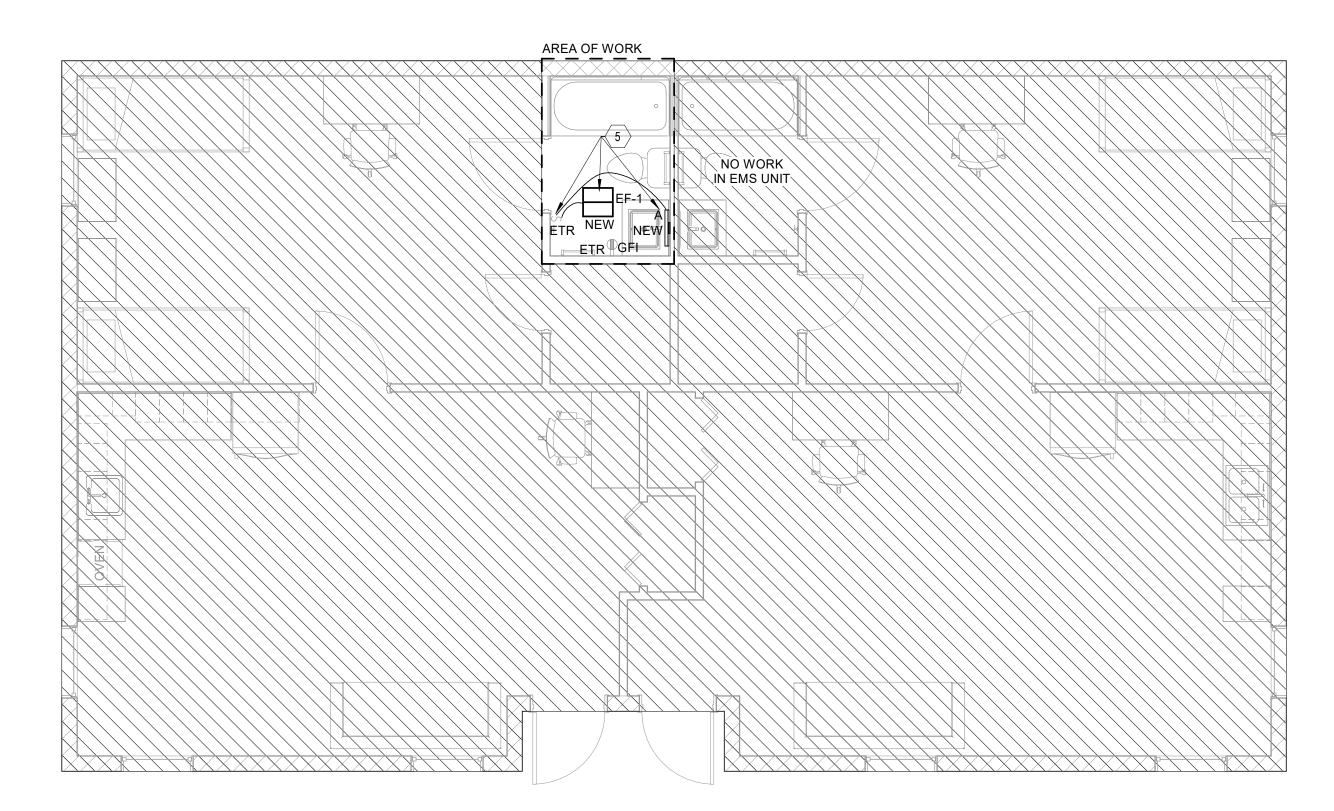

2 NEW ELECTRICAL PLAN - 1BR.C E111.C 1/4" = 1'-0"

> LIGHTING FIXTURE SCHEDULE C MANUFACTURER DESCRIPTION Apparent Load 18" LED WALL MOUNTED LINEAR SCONCE WAC Lighting - Brink Bathroom WS-77618-2700K-AL-16W 16 kVA MOUNT CENTERED ABOVE MIRROR AND CEILING.

× KEY NOTES

TOTAL LOAD REDUCED:

- 1. CONTRACTOR SHALL FIELD VERIFY THE EXISTING RECEPTACLE TO BE GFI IN EACH BATHROOM. IF EXISTING RECEPTACLE IS NOT GFI, CONTRACTOR SHALL REPLACE RECEPTACLE WITH A NEW GFI RECEPTACLE, AND CONNECT TO EXISTING CIRCUIT. CONFIRM FINAL COLOR WITH ARCHITECT. NO LOAD CHANGE.
- 2. CONTRACTOR SHALL DEMOLISH EXISTING CEILING LIGHTING FIXTURE AND PROVIDE A BLANK COVER PLATE. EXACT LOCATION OF LIGHT FIXTURE SHALL BE FIELD VERIFIED. LOAD OF REMOVED LIGHTING: 200W PER BATHROOM LOAD OF NEW CEILING & SCONCE FIXTURE: 26W PER BATHROOM
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# GENERAL SHEET NOTES

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- C. CONTRACTOR SHALL REUSE EXISTING BACKBOXES, CONDUIT AND WIRING TO FURTHEST EXTENT PRACTICAL. SUPPLEMENT WHERE NEEDED.
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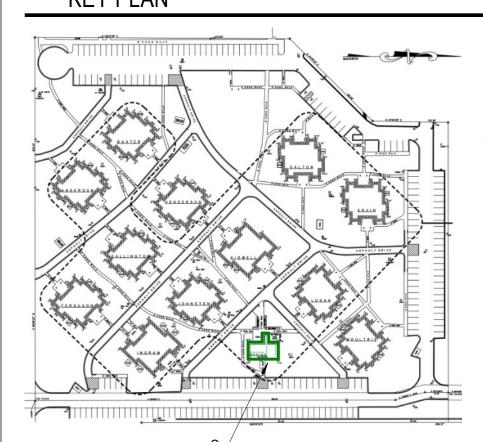
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1 OSE Comments

#### KEY PLAN



PROJECT TEAM PRINCIPAL IN CHARGE D BAUS


PROJECT MANAGER S KERSCHEN


DESIGN TEAM
SB, Matthew Schronce P.E. Village Apartments Interior Renovation, FMU

OSE PROJECT NUMBER -H18-N095-SG

ELECTRICAL PLANS - 1BR. C

E111.C

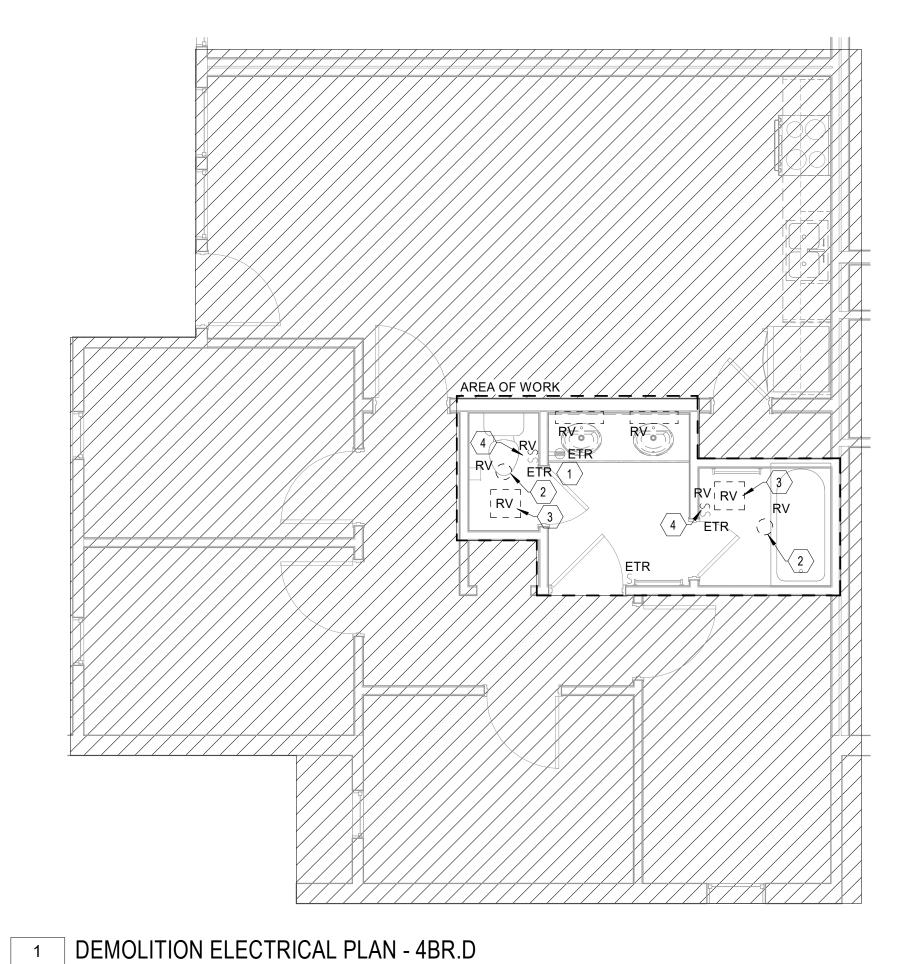

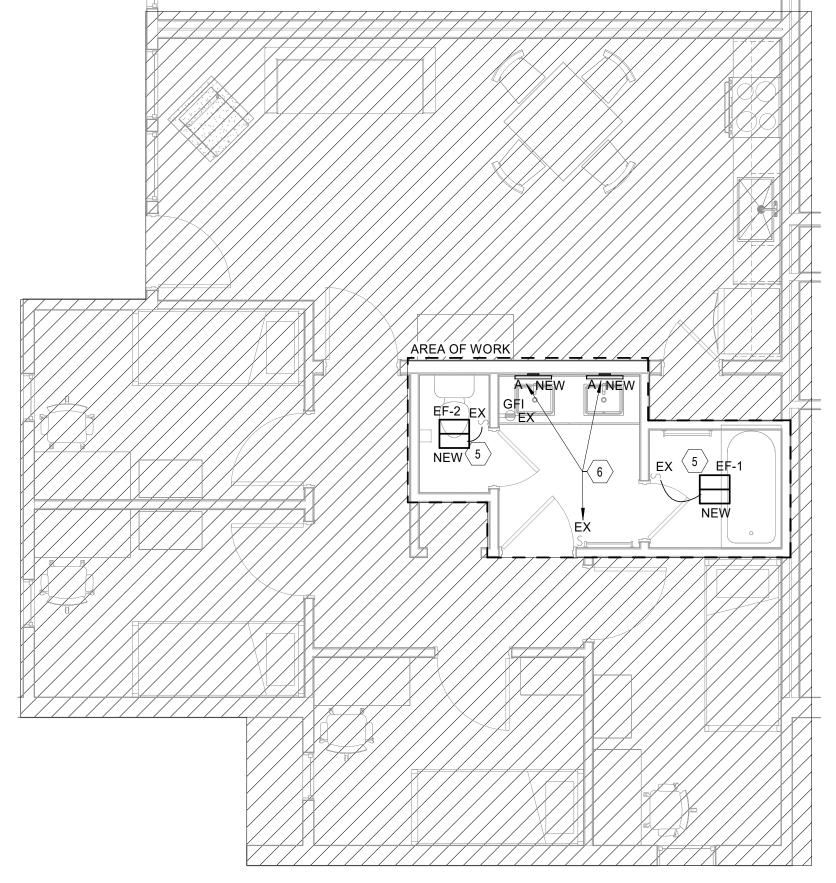

NEW ELECTRICAL PLAN - 4BR.D

E111.D 1/4" = 1'-0"

LIGHTING FIXTURE SCHEDULE D MANUFACTURER DESCRIPTION Apparent Load COMMENTS WAC Lighting - Brink Bathroom WS-77618-2700K-AL-16W 16 kVA Sconce MOUNT CENTERED ABOVE MIRROR AND CEILING. 18" LED WALL MOUNTED LINEAR SCONCE

× KEY NOTES

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- 3. CONTRACTOR SHALL DEMOLISH EXISTING EXHAUST FAN. THE CIRCUIT FOR THE EXISTING EXHAUST SHALL REMAIN FOR CONNECTION TO NEW FAN.

174W PER BATHROOM

- 4. CONTRACTOR SHALL DEMOLISH ONE TOGGLE SWITCH FURTHEST FROM THE DOOR. THE TOGGLE SWITCH CLOSET TO THE DOOR SHALL REMAIN TO CONNECT NEW FAN AND NEW LIGHTING TOGETHER. EXACT LOCATION OF TOGGLES SHALL BE FIELD VERIFIED. CONTRACTOR SHALL COORDINATE COLOR OF TOGGLE SWITCHES WITH THE ARCHITECT, AND REPLACE ONE FOR ONE IF EXISTING TOGGLE IS NOT THE COLOR THE ARCHITECT SPECIFIES.
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- . CONNECT NEW WALL MOUNTED SCONCES TO EXISTING CIRCUIT OF THE DEMOLISH SCONCES. CONTROL VIA THE EXISTING TOGGLE SWITCH IN THE ROOM AS SHOWN.

**GENERAL SHEET NOTES** 

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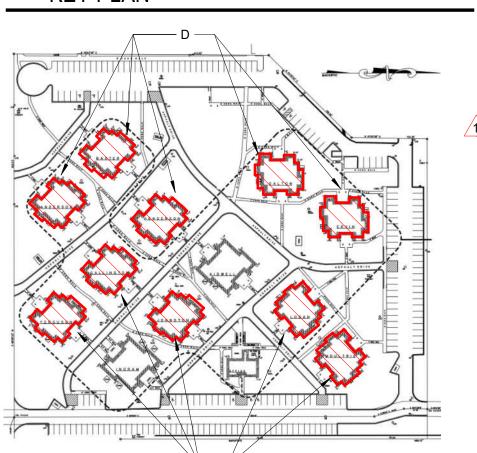
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02.14.2025

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**KEY PLAN** 

UNIT BASIS.



PROJECT TEAM PRINCIPAL IN CHARGE D BAUS PROJECT MANAGER


S KERSCHEN DESIGN TEAM
SB, Matthew Schronce P.E.

Village Apartments Interior Renovation, FMU

OSE PROJECT NUMBER -H18-N095-SG

ELECTRICAL PLANS - 4BR. D


E111.D

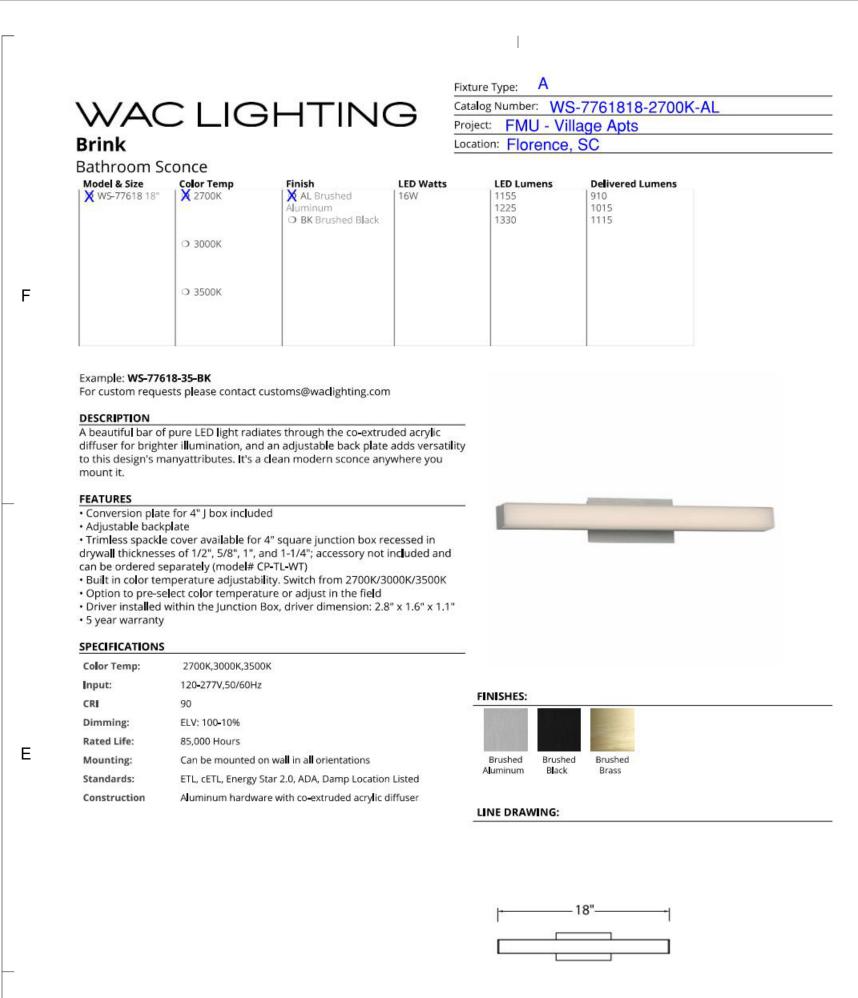

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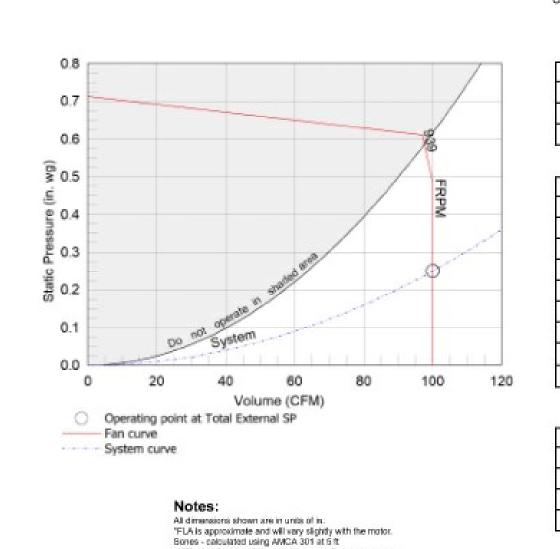
Motor Mounted

" Input Watts (W)


Enclosure

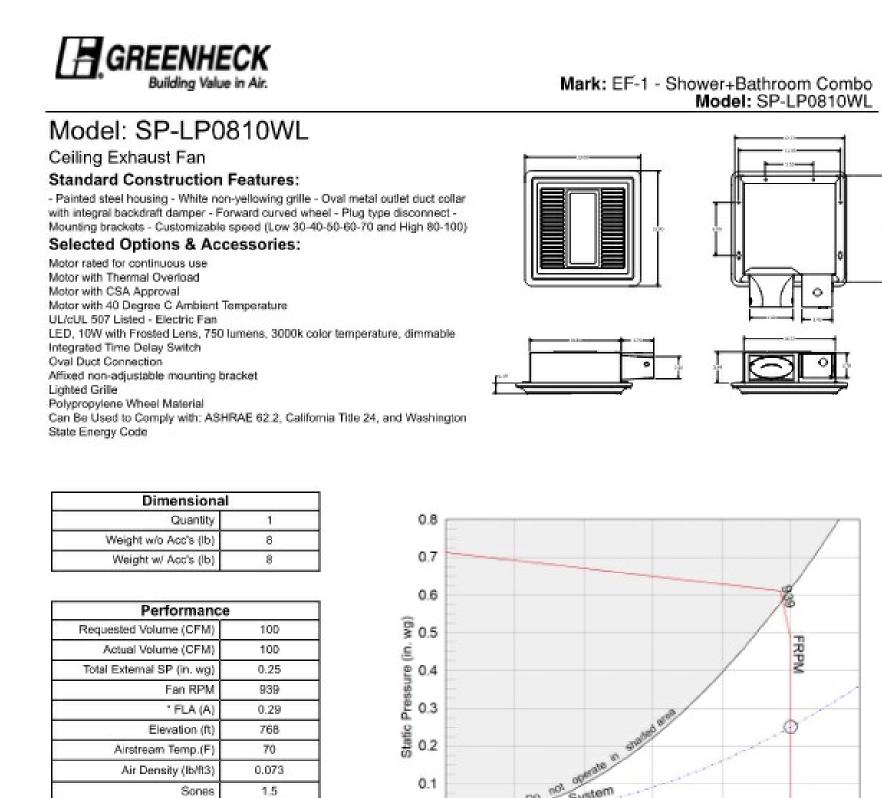115/60/1


Voltage/Cycle/Phase



Wattage is approximate and may vary between motors.

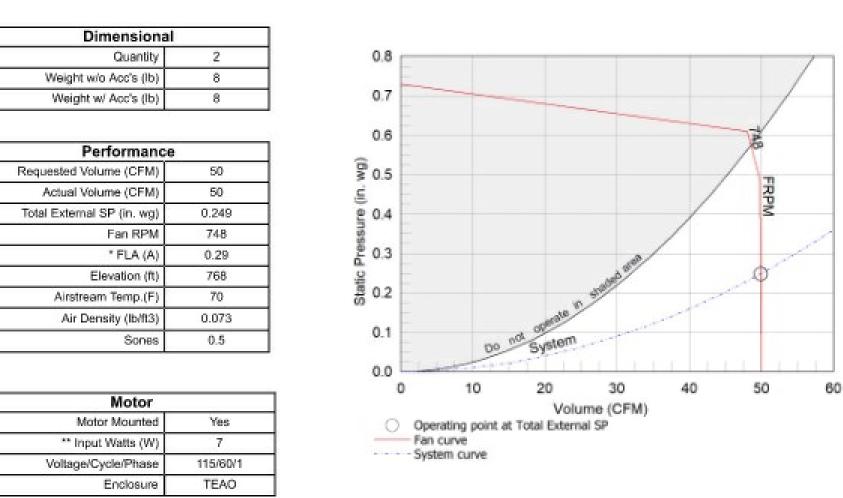

All dimensions shown are in units of in. "FLA is approximate and will vary slightly with the motor.

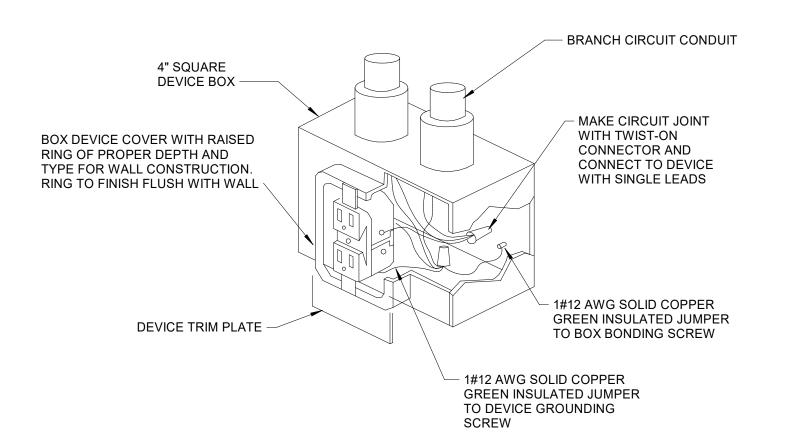

1 RECEPTACLE GROUNDING DETAIL E500 NOT TO SCALE

Model: SP-LP0810WL Ceiling Exhaust Fan


Standard Construction Features: - Painted steel housing - White non-yellowing grille - Oval metal outlet duct collar with integral backdraft damper - Forward curved wheel - Plug type disconnect -Mounting brackets - Customizable speed (Low 30-40-50-60-70 and High 80-100)

Selected Options & Accessories: Motor rated for continuous use Motor with Thermal Overload Motor with CSA Approval Motor with 40 Degree C Ambient Temperature

UL/cUL 507 Listed - Electric Fan LED, 10W with Frosted Lens, 750 lumens, 3000k color temperature, dimmable Integrated Time Delay Switch Oval Duct Connection Affixed non-adjustable mounting bracket

Lighted Grille Polypropylene Wheel Material Can Be Used to Comply with: ASHRAE 62.2, California Title 24, and Washington State Energy Code

	Motor
Yes	Motor Mounted
7	** Input Watts (W)
115/60/1	Voltage/Cycle/Phase
TEAO	Enclosure

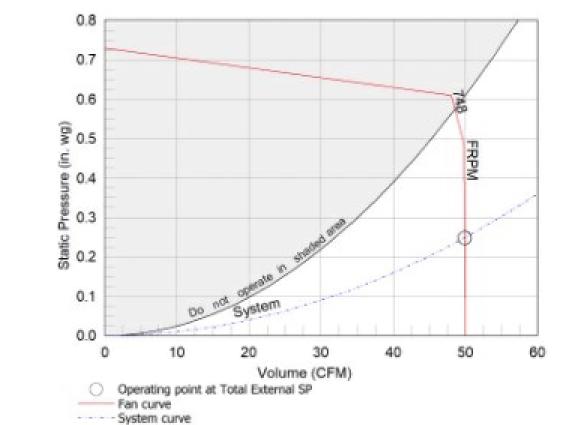

MarkEF-2Seperate shower bath Model: SP-LP0810WL

Sories - calculated using AVICA 301 at 5 ft.

"Wattage is approximate and may vary between motors.

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S KERSCHEN SB, Matthew Schronce P.E.

Village Apartments Interior

Renovation, FMU 

OSE PROJECT NUMBER -

H18-N095-SG PROJECT NO.

4142197600

SHEET TITLE ELECTRICAL DETAILS